CITY OF LEWISVILLE, TEXAS

CONSTRUCTION PLANS FOR

IH-35E UTILITY RELOCATION FOX AVE. TO W. COLLEGE ST.

RCSJ NO. 0196-02-135 CSJ NO. 0196-02-128 LEWISVILLE PROJECT NO. U1301

100% SUBMITTAL

CITY OFFICIALS

<u>MAYOR</u> TJ GILMORE

MAYOR PRO TEM KRISTEN GREEN

CITY COUNCIL


BOB TROYER
WILLIAM J. MERIDITH
RONNI CADE
BRANDON JONES

CITY MANAGER
DONNA BARRON

CITY ENGINEER

DAVID SALMON, P.E.



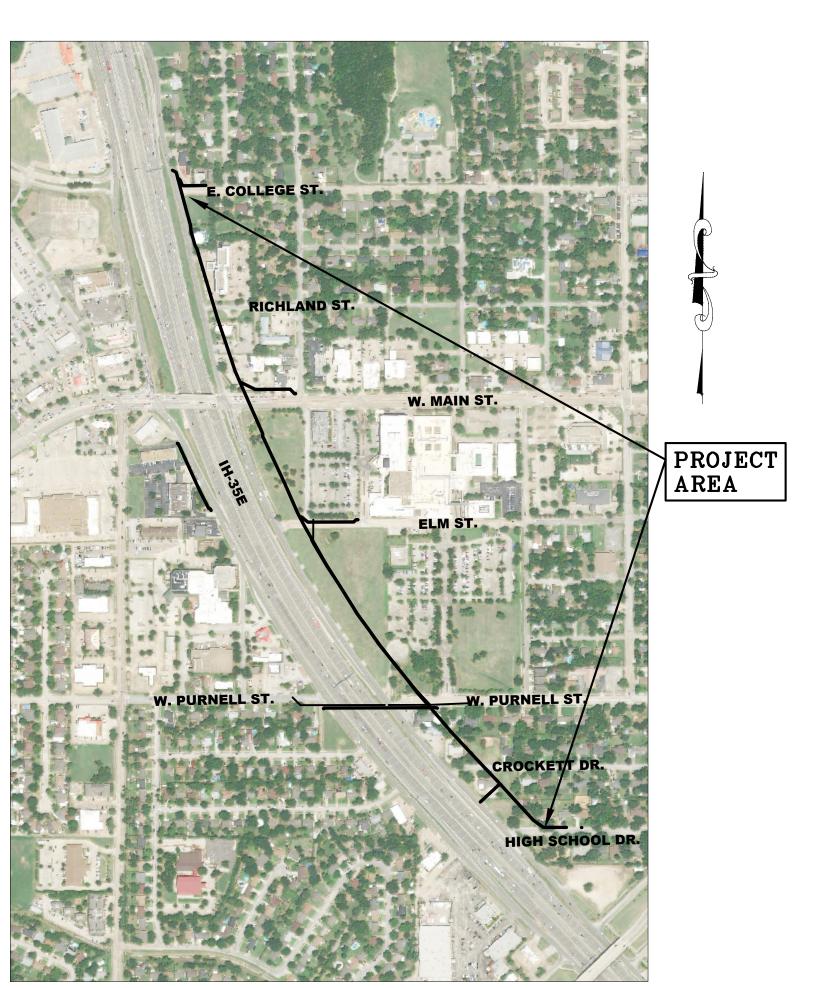

LOCATION MAP N.T.S.



RJN GROUP, INC. CONSULTING ENGINEERS 14755 PRESTON ROAD, SUITE 710 DALLAS, TEXAS 75254

December 2021

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WASTEWATER WW1 STA. 4+50 TO END

WASTEWATER PLAN & PROFILE

RJN GROUP INC.
Engineering infrastructure for tomorrow

Texas Registered Engineering Firm F-3260 14755 Preston Rd. Suite 710 Dallas TX 75254



12/2/2021

- CONTRACTOR MUST KEEP AVAILABLE ON-SITE AT ALL TIMES APPROVED CONSTRUCTION PLANS AND COPIES LEWISVILLE ENGINEERING STANDARDS AND NCTCOG SPECIFICATIONS.
- ALL CONSTRUCTION, TESTING, AND MATERIALS SHALL BE IN ACCORDANCE WITH THE CITY'S CURRENT 43. ALL WATER AND WASTEWATER CONSTRUCTION, TESTING, AND MATERIALS SHALL BE IN ACCORDANCE WITH
- STANDARDS, DETAILS AND SPECIFICATIONS. TESTING AND INSPECTION OF MATERIALS SHALL BE PERFORMED BY A COMMERCIAL TESTING LABORATORY APPROVED BY THE CITY. CONTRACTOR SHALL FURNISH MATERIALS OR SPECIMENS FOR TESTING, AND SHALL 44. ALL TRENCHING, EMBEDMENT, AND BACKFILL WILL BE INCIDENTAL TO THE UNIT COST OF PIPE. FURNISH SUITABLE EVIDENCE THAT THE MATERIALS PROPOSED TO BE INCORPORATED INTO THE WORK ARE
- IN ACCORDANCE WITH THE SPECIFICATIONS. CONTRACTOR SHALL NOTIFY THE CITY AT LEAST 48 HOURS PRIOR TO BEGINNING ANY CONSTRUCTION.
- 5. THE CITY OF LEWISVILLE'S INSPECTOR OVERTIME POLICY ALLOWS THE CONTRACTOR TO WORK FROM 7:00 4 A.M. TO 7:00 P.M., MONDAY THROUGH SATURDAY. ANY REQUEST TO WORK ON A SATURDAY MUST BE MADE PRIOR TO 12:00 P.M. ON THURSDAY AFTERNOON AND WILL REQUIRE A MINIMUM OF FOUR (4) HOUR CHARGE. THE CONTRACTOR SHALL PAY OVERTIME CHARGES OF \$45.00 PER HOUR TO THE CITY OF LEWISVILLE FOR WORK OUTSIDE THE NORMAL WORK WEEK (8:00 A.M. TO 5:00 P.M. MONDAY THROUGH FRIDAY). NO WORK IS ALLOWED ON SUNDAYS OR CITY HOLIDAYS WITHOUT WRITTEN APPROVAL FROM THE CITY ENGINEER OR DESIGNEE
- THE CONTRACTOR SHALL BE RESPONSIBLE FOR PROVIDING A TWO (2) YEAR, 100% MAINTENANCE BOND TO THE CITY OF LEWISVILLE FOR ALL PUBLIC IMPROVEMENTS (WATER, SANITARY SEWER, STORM DRAINAGE, PAVEMENT, SIDEWALK, SCREENING WALLS, TRAFFIC SIGNALS, PAVEMENT MARKINGS, AND EXCAVATION/FILL) WITHIN RIGHT-OF-WAYS OR EASEMENTS.
- NO WATER JETTING IS ALLOWED FOR WATER, SANITARY SEWER, OR STORM SEWER DRAINAGE
- CONSTRUCTION. CONTRACTOR IS RESPONSIBLE FOR OBTAINING ALL NECESSARY PERMITS AND APPROVALS PRIOR TO
- OF ANY REQUIRED PERMITS ALONG WITH THE CURRENT VERSIONS OF THE FOLLOWING REFERENCES: CITY OF
- LEWISVILLE ENGINEERING STANDARDS AND NCTCOG SPECIFICATIONS. 10. ALL TRENCHES THAT ARE EXCAVATED TO A DEPTH IN EXCESS OF FIVE (5) FEET SHALL BE EXCAVATED AND 6. THE USE OF FLY ASH IS NOT ALLOWED IN THE CONCRETE MIX DESIGN. MAINTAINED IN A MANNER THAT MEETS ALL OCCUPATIONAL SAFETY AND HEALTH ADMINISTRATION (OSHA) STANDARDS. PRIOR TO THE EXCAVATION AND CONSTRUCTION OF THE TRENCH(ES), THE CONTRACTOR SHALL BE RESPONSIBLE FOR SUBMITTING TWO (2) COPIES OF THE TRENCH SAFETY PLANS PREPARED BY A LICENSED GENERAL NOTES FOR EROSION CONTROL AND STORM WATER PROFESSIONAL ENGINEER IN ACCORDANCE WITH OSHA STANDARDS.
- 11. ALL EMBEDMENT AND BACKFILL SHALL BE WETTED TO APPROXIMATE OPTIMUM MOISTURE AND COMPACTED IN 1. EIGHT (8) INCH LIFTS TO 95% STANDARD PROCTOR DENSITY. DENSITY TESTS SHALL BE OBTAINED FOR EACH LIFT AND FOR EACH 150 LINEAL FEET OF TRENCH OR INCREMENT THEREOF. THE CONTRACTOR SHALL BE RESPONSIBLE FOR SUBMITTING A COPY OF ALL GEOTECHNICAL LABORATORY REPORTS/TEST RESULTS TO
- 12. THERE SHALL BE NO FILLING IN THE FLOODPLAIN OR DUMPING WITHIN THE CITY OF LEWISVILLE WITHOUT AN 2. APPROVED GRADING PLAN AND/OR FILL PERMIT. 13. THE CONTRACTOR SHALL BE RESPONSIBLE FOR RECORDING ALL FIELD CHANGES TO THE PLANS. THE
- PROJECT ENGINEER SHALL INCORPORATE THESE CHANGES IN THE "RECORD DRAWINGS".**** 14. THE CONTRACTOR SHALL BE RESPONSIBLE FOR ALL REQUIRED CONSTRUCTION SURVEYING AND STAKING
- AND SHALL NOTIFY THE CITY OF ANY DISCREPANCIES PRIOR TO PROCEEDING WITH ANY WORK.
- 15. CONTRACTOR SHALL BE RESPONSIBLE FOR PROTECTING ALL SURVEY MARKERS INCLUDING IRON RODS, PROPERTY CORNERS. OR SURVEY MONUMENTS WITHIN THE LIMITS OF CONSTRUCTION AND OUTSIDE ROW DURING CONSTRUCTION. ANY SURVEY MARKERS DISTURBED DURING CONSTRUCTION SHALL BE REPLACED BY THE CONTRACTOR AT NO COST TO THE CITY.
- 16. CONTRACTOR SHALL PROVIDE A CONSTRUCTION SCHEDULE WITH WEEKLY PROGRESS REPORTS AND THE CONTRACTOR SHALL PERIODICALLY REVISE AND RESUBMIT THE CONSTRUCTION SCHEDULE AS REQUIRED.
- 17. CONTRACTOR IS RESPONSIBLE FOR KEEPING STREETS AND DRIVEWAYS ADJACENT TO THE PROJECT FREE OF MUD AND DEBRIS AT ALL TIMES. CONTRACTOR SHALL CLEAN UP AND REMOVE ALL LOOSE MATERIAL RESULTING FROM CONSTRUCTION OPERATIONS. THE CONTRACTOR SHALL TAKE ALL AVAILABLE
- 18. THE EXISTENCE AND LOCATIONS OF THE PUBLIC AND FRANCHISE UTILITIES SHOWN ON THE DRAWING WERE WATER NOTES OBTAINED FROM THE AVAILABLE RECORDS AND ARE APPROXIMATE. THE CONTRACTOR SHALL DETERMINE 1. WATER LINES OF TWELVE (12) INCHES (NOMINAL) OR LESS IN DIAMETER SHALL BE AWWA STANDARD C900, THE DEPTH AND LOCATION OF EXISTING UNDERGROUND UTILITIES PRIOR TO EXCAVATING, TRENCHING, OR DRILLING AND SHALL BE REQUIRED TO TAKE ANY PRECAUTIONARY MEASURE TO PROTECT ALL LINES SHOWN 2 AND / OR ANY OTHER UNDERGROUND UTILITIES NOT OF RECORD OR NOT SHOWN ON THE PLANS. THE CONTRACTOR SHALL BE RESPONSIBLE FOR CONTACTING ALL PUBLIC AGENCIES AND FRANCHISE UTILITIES 48 HOURS PRIOR TO CONSTRUCTION (DIG-TESS 1-800-344-8377). THE CONTRACTOR MAY BE REQUIRED TO EXPOSE THESE FACILITIES AT NO COST TO THE CITY. THE CONTRACTOR WILL BE RESPONSIBLE FOR ' DAMAGES TO UTILITIES IF THE DAMAGE IS CAUSED BY NEGLIGENCE OR FAILURE TO HAVE LOCATES PREFORMED.
- PROPERTIES DURING CONSTRUCTION. ANY REMOVAL OR DAMAGE TO EXISTING FACILITIES SHALL BE REPLACED OR REPAIRED TO EQUAL OR BETTER CONDITION BY THE CONTRACTOR.
- TRAFFIC CONTROL IN ACCORDANCE WITH THE MINIMUM REQUIREMENTS OF THE LATEST REVISION OF THE TEXAS MANUAL ON UNIFORM TRAFFIC CONTROL DEVICES (TMUTCD) AND TXDOT BARRICADE AND CONSTRUCTION STANDARDS.
- 21. CONTRACTOR SHALL NOT IMPEDE TRAFFIC ON EXISTING STREETS, DRIVEWAYS, ALLEYS, OR FIRE LANES OPEN TO THE PUBLIC. IN THE EVENT THE CONSTRUCTION WORK REQUIRES THE CLOSURE OF AN EXISTING STREET, 8 DRIVEWAY, ALLEY OR FIRE LANE, THE CONTRACTOR SHALL REQUEST THE ROAD CLOSURE FROM THE CITY A MINIMUM OF 48 HOURS IN ADVANCE OF THE REQUESTED CLOSURE. CONTRACTOR MUST OBTAIN PERMISSION 9. PIPE JOINTS SHALL BE OF THE "PUSH-ON" TYPE UNLESS OTHERWISE NOTED. MONDAY THROUGH FRIDAY UNLESS OTHERWISE APPROVED BY THE CITY.
- 22. CONTRACTOR SHALL NOT STORE MATERIALS, EQUIPMENT, OR OTHER CONSTRUCTION ITEMS ON ADJACENT PROPERTIES OR RIGHT-OF-WAY WITHOUT THE PRIOR WRITTEN CONSENT OF PROPERTY OWNER AND THE 11. VALVES, VAULT LIDS, FIRE HYDRANTS AND METER BOXES SHALL BE LOCATED OUTSIDE OF SIDEWALK AREAS.
- 23. UNUSABLE EXCAVATED MATERIAL, OR CONSTRUCTION DEBRIS SHALL BE REMOVED AND DISPOSED OF OFFSITE AT AN APPROVED DISPOSAL FACILITY BY THE CONTRACTOR AT HIS EXPENSE.
- 24. CONTRACTOR SHALL AVOID DAMAGE TO EXISTING TREES. WHEN NECESSARY, TREES AND SHRUB TRIMMING FOR CONSTRUCTION SHALL BE PERFORMED BY A CERTIFIED TREE WORKER OR UNDER THE DIRECTION OF A REGISTERED LANDSCAPE ARCHITECT OR CERTIFIED ARBORIST. NO TREE TRIMMING OR TREE REMOVAL IS 14. ALL VERTICAL AND HORIZONTAL BENDS SHALL BE REVIEWED IN THE FIELD AND APPROVED BY THE CITY PERMITTED PRIOR TO CITY APPROVAL OF EACH TREE.
- 25. CONTRACTOR SHALL LOCATE AND PROTECT ALL EXISTING LANDSCAPE IRRIGATION SYSTEMS. DAMAGE TO 15. ALL WATER CONSTRUCTION, TESTING, AND MATERIALS SHALL BE IN ACCORDANCE WITH THE CITY'S CURRENT EXISTING IRRIGATION SYSTEMS AND LANDSCAPE MATERIALS SHALL BE RESTORED TO EQUAL OR BETTER CONDITION AT NO COST TO CITY BY A LICENSED IRRIGATION INSTALLER.
- 26. CONTRACTOR SHALL REPLACE ALL SIGNS, MAIL BOXES, LIGHT POLES, ELECTRIC AND UTILITY BOXES, AND ALL 16. CONTRACTOR SHALL VERIFY THE SIZE AND LOCATION OF ALL EXISTING ACTIVE WATER SERVICES AND SHALL OTHER STRUCTURES THAT ARE DAMAGED OR REMOVED DURING CONSTRUCTION (NO SEPARATE PAY ITEM).
- 27. CONTRACTOR SHALL REPLACE ALL DAMAGED SOD WITH BLOCK SOD WITH 4-INCH TOP SOIL IN ALL AREAS DISTURBED ALONG THE LENGTH OF THE PROJECT.
- 28. DAMAGED CURB AND GUTTER SHALL BE REPLACED WITH 6-INCH REINFORCED CONCRETE CURB AND GUTTER (SEE STANDARD DETAIL). 29. PAVEMENT REPAIR PAY QUANTITIES WILL BE LIMITED TO THE MAXIMUM TRENCH WIDTH PLUS TWO FEET
- UNLESS OTHERWISE SHOWN ON THE PLANS OR DIRECTED BY THE ENGINEER. ANY ADDITIONAL TRENCHING 18. ALL BOLTS, WASHERS, AND HEX NUTS SHALL BE STAINLESS STEEL. HIGH STRENGTH CORTEN T-HEAD BOLTS REQUIRED FOR TRENCH SAFETY PURPOSES SHALL BE CONSIDERED PART OF THE UNIT PRICE FOR TRENCH
- 30. THE CONTRACTOR SHALL NOT BE PERMITTED TO HAVE ANY OPEN TRENCHES AT THE END OF EACH WORKING DAY UNI ESS APPROVED BY THE ENGINEER
- OF THE PUBLIC, THE CONTRACTOR SHALL BE REQUIRED TO ERECT TEMPORARY CONSTRUCTION FENCING, WHICH, WHERE DEEMED NECESSARY, MAY INCLUDE CHAIN LINK FENCE (NON-PAY ITEM). 32. ALL CUT AND FILL SLOPES SHALL BE 4:1 EXCEPT AS NOTED ON THE PLANS OR AS DIRECTED BY THE ENGINEER. CUT SLOPES MAY BE STEEPENED TO PROTECT EXISTING TREES AND FENCES ONLY WITH PRIOR APPROVAL OF THE ENGINEER. ALL PROPERTY ADJACENT TO THE PROPOSED CONSTRUCTION SHALL BE
- GRADED AS DIRECTED BY THE ENGINEER (NON-PAY ITEM).
- PROTECT IT FROM TRACK MARKS AND/OR CRACKING DURING CONSTRUCTION (NON-PAY ITEM). 34. ALL DISTURBED AREAS SHALL BE FINISHED TO GRADE, SMOOTHED WITH A SUITABLE CEMENT FREE TOP SOIL
- (2" MINIMUM) AND SEEDED OR SODDED AS OUTLINED IN THE SPECIFICATIONS OR DIRECTED BY THE ENGINEER. 35. ALL EXISTING PAVEMENT, CURB AND GUTTER, AND SIDEWALK TO BE REMOVED SHALL BE DISPOSED OF BY THE CONTRACTOR.
- 36. THE CONTRACTOR SHALL GIVE THE CITY, RESIDENTS AND BUSINESSES AFFECTED BY ANY ANTICIPATED WATER OR WASTEWATER SERVICE DISRUPTIONS AT LEAST FORTY EIGHT (48) HOURS PRIOR NOTICE. . THE CONTRACTOR IS RESPONSIBLE FOR LOCATING, PROTECTING, SUPPORTING AND/OR BRACING ALL
- UNDERGROUND UTILITIES (MAINS OR SERVICES), POWER POLES AND/OR LIGHT POLES WITHIN THE PROJECT 25. THE CONTRACTOR SHALL TRANSFER ALL EXISTING METERED SERVICES AFTER THE PROPOSED WATER MAIN LIMITS. ANY DAMAGE TO THE SAME SHALL BE IMMEDIATELY REPORTED TO APPLICABLE AUTHORITIES, OWNER'S, CITY'S FRANCHISE UTILITY SUPERVISOR, AND CITY'S ENGINEERING INSPECTOR. DAMAGED WATER & WASTEWATER MAINS/SERVICES SHALL BE IMMEDIATELY REPAIRED/REPLACED AT THE DIRECTION OF AND 26. ALL GATE VALVES TO BE ABANDONED SHALL HAVE THE VALVE STACKS REMOVED AND BACKFILLED. ALL NO ADDITIONAL COST TO THE CITY. OTHER UTILITIES DAMAGED BY CONSTRUCTION ACTIVITIES SHALL BE REPAIRED/REPLACED BY THE RESPECTIVE OWNER AT THEIR DISCRETION AND SCHEDULE AND AT NO ADDITIONAL COST TO THE CITY. ANY DAMAGE TO EXISTING PAVEMENT, SUBGRADE, SIDEWALKS, BUS PADS. IRRIGATION SYSTEMS, SOD, ETC. THAT ARE DIRECTLY RELATED TO THE REPAIR/REPLACEMENT OF A DAMAGED 27. ANY GATE VALVES REQUIRED TO BE REMOVED DURING CONSTRUCTION SHALL BECOME THE PROPERTY OF UNDERGROUND UTILITY SHALL BE REPAIRED/REPLACED AT THE DIRECTION OF AND NO ADDITIONAL COST TO
- 38. THE CONTRACTOR SHALL MAINTAIN ACCESS TO ALL WATER METERS TO FACILITATE THE READING OF THE 28. THE FIRE HYDRANTS AND SHOES WHICH ARE REMOVED FROM THE EXISTING MAIN SHALL REMAIN THE METERS BY THE CITY'S METER READERS AND SHALL MAINTAIN ACCESS TO EXISTING VALVES, MANHOLES, METERS AND CLEANOUTS FOR CITY PERSONNEL IN CASE OF EMERGENCY CUT OFFS OR WASTEWATER OVERFLOWS.
- 39. ALL EXISTING UTILITY SIZES AND LOCATIONS SHOWN ON PLANS ARE APPROXIMATE. CONTRACTOR MUST FIELD 29. THE CONTRACTOR SHALL DECHLORINATE THE WATER AS REQUIRED IN THE PROPOSED MAIN AFTER VERIFY ALL EXISTING UTILITY SIZES BEFORE ORDERING MATERIALS. NO COMPENSATION WILL BE MADE FOR
- ORDERING THE WRONG SIZE WHEN FIELD VERIFICATION OF EXISTING UTILITIES DIFFERS FROM WHAT IS SHOWN ON THE PLANS, ANY WASTEWATER NOTES SUPPOSED DISCREPANCY SHALL BE IMMEDIATELY BROUGHT TO THE ENGINEERS ATTENTION BEFORE PROCEEDING.

- 41. IF THE CONTRACTOR IS NOT PROVIDING ADEQUATE TRAFFIC CONTROL, INCLUDING BUT NOT LIMITED TO FLAG 2. MANHOLES SHALL BE PRECAST, UNLESS OTHERWISE APPROVED BY THE CITY. CONTRACTOR HAS A MEETING WITH THE CITY ENGINEER.
- OF ANY REQUIRED PERMITS ALONG WITH THE CURRENT VERSIONS OF THE FOLLOWING REFERENCES: CITY OF 42. ANY ABANDONED UTILITIES IN CONFLICT WITH PROPOSED UTILITIES IN CONFLICT WITH PROPOSED UTILITIES SHALL BE REMOVED TO FACILITATE 4. THE CONTRACTOR SHALL MAINTAIN FLOW IN THE EXISTING WASTEWATER MAIN LINES AND PROVIDE ALL PROPER INSTALLATION OF THE PROPOSED UTILITIES, NON-PAY ITEM.
 - THE CITY'S CURRENT STANDARDS, DETAILS, AND SPECIFICATIONS UNLESS OTHERWISE NOTED, AND WITH 5. NCTCOG STANDARD CONSTRUCTION SPECIFICATIONS, 4TH EDITION.

GENERAL NOTES FOR PAVING

- PROPOSED PAVING OR PAVING REMOVED FOR CONSTRUCTION TO BE REPLACED SHALL BE 4,200 PSI 8. THE CONTRACTOR SHALL BE RESPONSIBLE FOR LOCATING AND CONNECTING THE EXISTING WASTEWATER CONCRETE AT 3 DAYS (#4 BARS AT 18-INCHES) WITH A 6-INCH SUBGRADE SCARIFIED AND COMPACTED TO 95% PROCTOR DENSITY AT OPTIMUM MOISTURE CONTENT OF +/-2%.
- ALL PAVING CONSTRUCTION, TESTING, AND MATERIALS, INCLUDING CONCRETE, REINFORCEMENT, JOINTING, AND SUBGRADE PREPARATIONS AND TREATMENT SHALL BE IN ACCORDANCE WITH THE CITY'S CURRENT STANDARDS, DETAILS, AND SPECIFICATIONS AND THE NCTCOG STANDARD CONSTRUCTION SPECIFICATIONS, 5TH EDITION UNLESS OTHERWISE NOTED.
- ABSOLUTELY NO EARTHWORK OR OTHER PREPARATION OF THE SUBGRADE FOR PAVING STREETS, ALLEYS, OR FIRE LANES SHALL BE INITIATED WITHOUT AUTHORIZATION FROM THE CITY. THE CITY WILL AUTHORIZE THE SUBGRADE WORK IN PREPARATION FOR PAVING AFTER UTILITY TRENCH BACKFILL TESTING HAS BEEN COMPLETED AND VERIFIED TO MEET CITY REQUIREMENTS.
- AMERICAN WITH DISABILITIES ACT ACCESSIBILITY GUIDELINES (ADAAG) AND THE TEXAS ACCESSIBILITY STANDARDS (TAS). THE CONTRACTOR SHALL REMOVE AND REPLACE ANY CONSTRUCTED OR INSTALLED ITEMS 9. NOT MEETING THE CURRENT ADAAG AND TAS REQUIREMENTS AT NO ADDITIONAL COST TO THE CITY. CONTRACTOR MUST KEEP AVAILABLE ON-SITE AT ALL TIMES APPROVED CONSTRUCTION PLANS AND COPIES 5. THE CONTRACTOR SHALL REMOVE AND REPLACE ANY CONCRETE PAVEMENT (DRIVE APPROACHES / STREET PANELS) WITHIN FIVE (5) DAYS OF SAW CUTTING THE PAVEMENT. CONCRETE PAYMENT SUBJECT TO

CONTRACTOR IS RESPONSIBLE FOR ENSURING ALL PEDESTRIAN WORK MEETS OR EXCEEDS THE CURRENT

VEHICULAR TRAFFIC SHALL HAVE COMPRESSIVE STRENGTH OF 4,200 PSI AT 3 DAYS. ***

- THE CONTRACTOR SHALL BE RESPONSIBLE FOR PROVIDING EROSION CONTROL IN ACCORDANCE WITH THE EROSION CONTROL IN ACCORDANCE WITH THE EROSION CONTROL PLAN PREPARED BY THE ENGINEER AND 10. CLEAN OUTS WILL BE INSTALLED AT THE PROPERTY LINE ON EACH WASTEWATER LATERAL. AS IDENTIFIED ON THE STORM WATER POLLUTION PREVENTION PLAN (S.W.P.P.P.) PREPARED BY THE 11. ABANDONMENT OF EXISTING CLEAN OUTS IS A NON-PAY ITEM AND IS CONSIDERED SUBSIDIARY TO CONTRACTOR. THE CONTRACTOR SHALL INSTALL ADDITIONAL EROSION CONTROL DEVICES WHEN FIELD CONDITIONS WARRANT OR AS DIRECTED BY THE CITY OF LEWISVILLE INSPECTOR.
- THE PERMITTED OPERATOR SHALL SUBMIT COPIES OF THE SWPPP, NOTICE OF INTENT (N.O.I.) AND THE TRAFFIC AND ACCESS CONTROL NOTICE OF TERMINATION (N.O.T.) AND THE NOTICE OF TERMINATION (N.O.T.) TO THE CITY OF LEWISVILLE FOR APPROVAL AS PART OF THE SUBMITTAL TO THE TEXAS COMMISSION ON ENVIRONMENTAL QUALITY (TCEQ). 1. STEEL POST SHALL NOT BE USED TO INSTALL EROSION CONTROL MEASURES WITHIN CITY ROW
- NO EQUIPMENT SHALL BE CLEANED ON-SITE. OR OTHER LIQUIDS DEPOSITED AND ALLOWED TO FLOW OVERLAND OR SUBTERRANEAN WITHIN THE LIMITS OF THE CRITICAL ROOT ZONE OF TREES THAT REMAIN ON SITE. THIS INCLUDES PAINT, OIL, SOLVENTS, ASPHALT, CONCRETE, CONCRETE EQUIPMENT WASH WATER, MORTAR OF SIMILAR MATERIALS. ALL CONSTRUCTION ACTIVITIES SHALL COMPLY WITH ALL GOVERNING 2. AGENCIES, ENTITIES, AND CITY ORDINANCES AND REGULATIONS.
- EROSION CONTROL DEVICES SHALL BE INSTALLED ON ALL PROJECTS AS PER PLAN PRIOR TO BEGINNING CONSTRUCTION AND SHALL BE MAINTAINED THROUGHOUT THE PROJECT IN A CONDITION ACCEPTABLE TO THE CITY
- 6. CONTRACTOR SHALL PROVIDE STORM WATER POLLUTION PREVENTION PLAN (SWPPP) AT CONTRACTOR'S EXPENSE AND DELIVER TO PRE-CONSTRUCTION MEETING. ALL SWPPP COST SHALL BE SUBSIDIARY TO 3. EROSION CONTROL BID ITEMS.

- CLASS 235 (DR-18).
- ALL WATER MAINS SHALL HAVE A 42-INCH MINIMUM COVER FROM FINISHED GRADE TO TOP OF PIPE. ALL WATER MAIN PIPE FITTINGS WILL BE IN ACCORDANCE WITH THE CITY OF LEWISVILLE STANDARD DETAILS AND SPECIFICATIONS.
- FITTINGS SHALL BE EITHER GRAY OR DUCTILE IRON AND SHALL BE CEMENT LINED INSIDE AND BITUMINOUS COATED ON THE OUTSIDE. WHERE CONNECTIONS ARE MADE TO PIPES OF DISSIMILAR MATERIALS, SUITABLE ADAPTORS SHALL BE USED.
- 19. THE CONTRACTOR SHALL BE RESPONSIBLE FOR ANY DAMAGE TO EXISTING FACILITIES OR ADJACENT 5. ALL DUCTILE IRON FITTINGS SHALL BE OF MECHANICAL JOINT TYPE OR SLIP JOINT TYPE AND SHALL BE CLASS D OR CLASS 2500N SIZES 12" OR SMALLER IN ACCORDANCE WITH AWWA SPECIFICATION C-110-12 AND
- 20. CONTRACTOR SHALL BE RESPONSIBLE FOR FURNISHING AND INSTALLING ALL TEMPORARY AND PERMANENT 6. ALL FIRE HYDRANTS SHALL MEET THE CITY OF LEWISVILLE STANDARD FIRE HYDRANT SPECIFICATIONS. FIRE HYDRANT SHALL BE MUELLER SUPER CENTURION, CLOW MEDALLION, WATEROUS WB-67, OR EQUAL WITH CITY **APPROVAL**
 - INSPECTOR ALL EXISTING FIRE HYDRANTS ON WATER LINES THAT WILL BE PLUGGED/KILLED AS PART OF THIS PROJECT SHALL BE REMOVED, SALVAGED AND DELIVERED TO A LOCATION ACCEPTABLE TO THE CITY.

THE LOCATION OF ALL NEW FIRE HYDRANTS SHALL BE REVIEWED IN THE FIELD AND APPROVED BY THE CITY

- PRIOR TO ANY ROAD CLOSURES. CLOSURES WILL NOT BE ALLOWED PRIOR TO 9:00 A.M. OR AFTER 3:30 P.M., 10. VALVES 12-INCH AND SMALLER SHALL BE GATE VALVES SHALL BE FLANGED. GATE VALVES ON LATERALS SHALL BE ATTACHED TO A FLANGED OUTLET, TEE OR CROSS. VALVES SHALL CONFORM TO AWWA
 - 12. CONTRACTOR SHALL NOT OPERATE EXISTING VALVES. CONTACT THE CITY'S PUBLIC WORKS DEPARTMENT TO
 - REQUEST VALVE CHANGE. 13. ALL VALVES SHALL BE ABANDONED ON EXISTING WATER LINES THAT WILL BE KILLED/ABANDONDED AS PART OF THIS PROJECT. CONTRACTOR SHALL REMOVE EACH VALVE COVER/LID AND FILL THE VALVE STACK WITH
 - SAND OR 2 SACK CONCRETE MIX. (NO SEPARATE PAY ITEM).
 - STANDARDS, DETAILS, AND SPECIFICATIONS UNLESS OTHERWISE NOTED, AND WITH NCTCOG STANDARD CONSTRUCTION SPECIFICATIONS, 4TH EDITION.
 - CONSTRUCT NEW SERVICE LINES FROM THE NEW WATER MAIN TO THE METER PRIOR TO KILLING THE EXISTING WATER MAIN. EACH METER SHALL HAVE A DEDICATED SERVICE LINE FROM THE NEW MAIN. THE SERVICE LINE SHALL INCLUDE CORPORATION AND CURB STOPS, AS SHOWN ON THE CITY OF LEWISVILLE STANDARD DETAIL. THE EXISTING METERS AND METER BOXES WILL NOT BE REPLACED.
 - 17. ALL EXISTING WATER MAINS THAT WILL BE KILLED AND ABANDONED SHALL BE FILLED WITH FLOWABLE GROUT AFTER NEW MAIN IS PLACED IN SERVICE.
 - AS APPLICABLE. STAINLESS PLATING NOT ACCEPTABLE. 19. THE CUTTING AND PLUGGING OF EXISTING WATER LINES, TEES, CROSSES, ETC. ASSOCIATED WITH THE
- DIRECT CONNECTION OF NEW WATER MAINS TO EXISTING MAINS SHALL BE CONSIDERED AS PART OF THE UNIT PRICE FOR WET CONNECTIONS. 31. IN OPEN CONSTRUCTION AREAS THAT MAY POSE A POTENTIAL RISK TO THE HEALTH, SAFETY AND WELFARE 20. THE CONTRACTOR SHALL CENTER A FULL 20 FOOT LONG JOINT OF THE PROPOSED PIPE AT A STORM DRAIN
 - CROSSING IF THE PROPOSED PIPE MUST PASS UNDER THE STORM DRAIN. 21. PROPOSED OR EXISTING WATER LINES CROSSING PROPOSED OR EXISTING WASTEWATER LINES SHALL COMPLY WITH THE RULES OF THE TEXAS COMMISSION ON ENVIRONMENTAL QUALITY (TCEQ) AS DESCRIBED IN CHAPTER 217: DESIGN CRITERIA FOR DOMESTIC WASTEWATER SYSTEMS AND CHAPTER 290: PUBLIC DRINKING
- 22. ALL DUCTILE IRON FITTINGS SHALL BE POLYWRAPPED. 33. WHERE APPLICABLE, THE CONTRACTOR SHALL PLACE RUBBER MATS OR EARTH ON THE PAVEMENT TO 23. A MINIMUM OF ONE (1) FOOT CLEARANCE (HORIZONTALLY OR VERTICALLY AT THE DISCRETION OF THE CITY) SHALL BE REQUIRED BETWEEN THE PROPOSED WATER LINE AND DRAINAGE STRUCTURES OR STORM DRAINAGE PIPE. THE CONTRACTOR SHALL NOT BE PERMITTED TO USE BENDS (UNLESS SHOWN ON THE PLANS OR DIRECTED BY THE ENGINEER) TO MEET THE ABOVE MENTIONED CRITERIA. THE CONTRACTOR SHALL DEFLECT THE PIPE TO ACHIEVE THE MINIMUM VERTICAL SEPARATION. THE CONTRACTOR SHALL PROVIDE CUT STAKES AT ALL DRAINAGE STRUCTURES AND STORM DRAIN PIPE CROSSINGS TO VERIFY THE WATER MAIN DEPTH
 - 24. WATER LINES ALLOWED TO BE CONSTRUCTED UNDER ANY PROPOSED CURB INLETS SHALL BE STEEL ENCASED
 - HAS BEEN TESTED AND APPROVED BY THE ENGINEER. NO SERVICE SHALL BE DISRUPTED FOR A PERIOD LONGER THAN SIX (6) HOURS. ALL SERVICES SHALL BE 3/4", 1", 1-1/2", OR 2" EXCEPT AS NOTED ON THE PLANS. VALVE STACKS DEEMED SATISFACTORY BY THE ENGINEER MAY BE UTILIZED DURING THE CONSTRUCTION OF THE PROPOSED VALVES. THE REMOVAL OF SAID VALVE STACKS BY THE CONTRACTOR SHALL BE CONSIDERED
 - THE CITY OF LEWISVILLE AND THE CONTRACTOR SHALL TRANSPORT ALL ABANDONED GATE VALVES TO THE CITY OF LEWISVILLE, UNLESS OTHERWISE DIRECTED BY THE ENGINEER (NON-PAY ITEM).
 - PROPERTY OF THE CITY OF LEWISVILLE. THE CONTRACTOR SHALL EXERCISE CARE SO AS NOT TO DAMAGE THE FIRE HYDRANTS AND SHOES WHEN REMOVED FROM THE EXISTING MAIN OR WHEN TRANSPORTED TO THE CITY OF LEWISVILLE. SUBSIDIARY TO OTHER BID ITEMS.
 - STERILIZATION (SECTION 33 04 40).

A NON-PAY ITEM

WATER OF THE TEXAS ADMINISTRATIVE CODE.

1. SANITARY SEWER LINES SHALL BE PVC SDR 35 OR AS NOTED ON THE CONSTRUCTION PLANS.

MEN, WORK SHALL BE STOPPED IMMEDIATELY AND SHALL NOT BE ALLOWED TO CONTINUE UNTIL THE 3. THE CONTRACTOR SHALL PERFORM A TELEVISION INSPECTION OF THE NEW SANITARY SEWER LINE AS PER THE CITY OF LEWISVILLE GENERAL DEVELOPMENT ORDINANCES.

> WASTEWATER BY-PASSES AS REQUIRED TO PERFORM THE WORK UNTIL ALL CONNECTIONS HAVE BEEN MADE TO THE PROPOSED SYSTEM (NON-PAY ITEM). ALL CONNECTIONS TO EXISTING AND PROPOSED MANHOLES SHALL BE CONSIDERED AS A NON-PAY ITEM.

ALL EXISTING WASTEWATER MAINS TO BE ABANDONED SHALL BE FILLED WITH SAND OR GROUT BY THE CONTRACTOR AS NOTED ON THE PLANS AND SHALL BE PAID PER LINEAR FOOT PER SECTION 02 41 14. 7. ALL MANHOLE CASTINGS AND FRAMES WHICH ARE REMOVED IN ASSOCIATION WITH SECTION 02 41 14 "UTILITY REMOVAL ABANDONMENT" SHALL REMAIN THE PROPERTY OF THE CITY OF LEWISVILLE AND SHALL BE

TRANSPORTED BY THE CONTRACTOR TO THE CITY OF LEWISVILLE. (SUBSIDIARY TO SECTION 02 41 14).


SERVICES TO THE NEW WASTEWATER MAIN. ALL WASTEWATER SERVICE TRANSFERS TO THE NEW MAIN SHALL BE MADE AFTER THE MAIN HAS BEEN TESTED AND APPROVED (EXCEPT WHEN THE PROPOSED WASTEWATER LINE IS TO BE PLACED IN THE SAME TRENCH AS THE EXISTING WASTEWATER LINE) OR AS DIRECTED BY THE ENGINEER. NO WASTEWATER SERVICE SHALL BE DISRUPTED LONGER THAN SIX (6) HOURS, ALL WASTEWATER SERVICES SHALL BE FOUR (4) INCH P.V.C. OF THE SAME SDR AS THE MAIN THE SERVICE IS BEING CONNECTED TO, EXCEPT AS NOTED BY THE ENGINEER. THE CONTRACTOR MAY OPEN CUT DRIVEWAYS TO INSTALL WASTEWATER SERVICES UNLESS SPECIFIED OTHERWISE ON THE PLANS. ALL SERVICES UNDER EXISTING PAVEMENT SHALL BE BORED. THE ENGINEER MAY CHANGE AND ALTER THE LINE, GRADE AND FORM OF THE PROPOSED WASTEWATER SERVICES AS MAY BE NECESSARY OR DESIRABLE TO INSURE COMPLETION OF SUCH SERVICES IN THE MOST SATISFACTORY MANNER. SUCH CHANGES SHALL NOT BE CONSIDERED SUFFICIENT BASIS FOR CLAIMS FOR ADDITIONAL COMPENSATION FOR EXTRA WORK OR FOR INCREASING THE PAY QUANTITIES IN ANY MANNER WHATSOEVER.

WHEN THE PROPOSED WASTEWATER LINE IS TO BE PLACED IN THE SAME TRENCH AS THE EXISTING WASTEWATER LINE, THE CONTRACTOR SHALL FURNISH ALL EQUIPMENT, MATERIALS AND LABOR REQUIRED TO ROUTE THE UPSTREAM WASTEWATER FLOW IN THE EXISTING WASTEWATER LINE INTO THE DOWNSTREAM MANHOLE AND INTO THE PROPOSED WASTEWATER LINE THAT IS INSTALLED DOWNSTREAM DURING THE CONSTRUCTION (NON-PAY ITEM). THE CONTRACTOR SHALL INSTALL THE WASTEWATER SERVICES AND TRANSFER THE SANITARY SERVICES AS THE PROPOSED WASTEWATER LINE IS INSTALLED. THE CONTRACTOR SHALL REMOVE THE EXISTING WASTEWATER MAIN AS THE PROPOSED MAIN IS INSTALLED (NON-PAY ITEM). THE CONTRACTOR SHALL NOT BE REQUIRED TO PRESSURE TEST THIS SECTION OF THE PROPOSED LINE AFTER THE INSTALLATION IS COMPLETED. THE CONTRACTOR SHALL MAKE A TEMPORARY CONNECTION BETWEEN THE PROPOSED WASTEWATER LINE THAT IS INSTALLED AND THE EXISTING WASTEWATER LINE AT THE END OF EACH WORKING DAY TO MAINTAIN FLOW IN THE WASTEWATER LINE (NON-PAY ITEM).

ABANDONMENT OF WASTEWATER MAIN.

- THE CONTRACTOR SHALL ROUTE TRAFFIC AND BARRICADE ALL ROADS AS REQUIRED BY THE CITY. THE CONTRACTOR SHALL ALSO ROUTE TRAFFIC AND BARRICADE ALL ROADS AS REQUIRED BY THE TEXAS DEPARTMENT OF TRANSPORTATION (TXDOT) WHEN CONSTRUCTION IS WITHIN TXDOT RIGHT-OF-WAY. ALL BARRICADES, SIGNS AND TRAFFIC CONTROL DEVICES REQUIRED FOR THE PROJECT SHALL BE PAID PER SECTION 34 71 13 OF THESE SPECIFICATIONS.
- THE CONTRACTOR SHALL SUBMIT A TRAFFIC CONTROL PLAN AT LEAST TWO BUSINESS DAYS PRIOR TO ANY CONSTRUCTION WITHIN THE PUBLIC STREET RIGHT-OF-WAY. BARRICADES, TEMPORARY PAVEMENT MARKINGS, AND SIGNS SHALL BE MAINTAINED IN GOOD CONDITION MEETING THE LEGIBILITY AND RETROREFLECTIVITY REQUIREMENTS OF THE CURRENT EDITION OF THE TEXAS MANUAL ON UNIFORM TRAFFIC CONTROL DEVICES UNTIL THE COMPLETION AND ACCEPTANCE OF ALL WORK WITHIN THE PUBLIC RIGHT-OF-WAY OR UNTIL CONTRACTOR IS DIRECTED OTHERWISE.
- ELECTRONIC ARROW DISPLAYS (PANEL TYPE B OR C) MEETING THE REQUIREMENTS OF PART VI, SECTION 6F-3 OF THE LATEST EDITION OF THE TEXAS MANUAL ON UNIFORM TRAFFIC CONTROL DEVICES FOR STREETS AND HIGHWAYS SHALL BE USED FOR ALL LANE CLOSURES ON ANY STREET OR HIGHWAY DESIGNATED ON THE CURRENT EDITION OF THE CITY OF IRVING MASTER THOROUGHFARE PLAN, AND AT ANY ADDITIONAL LOCATION SPECIFICALLY IDENTIFIED AS REQUIRING ARROW DISPLAY TRAFFIC CONTROL ON THE TRAFFIC CONTROL PLAN FOR THIS PROJECT IF THAT FACILITY IS OPENED TO PUBLIC TRAFFIC. COPIES OF THE CITY OF IRVING COMPREHENSIVE PLAN MASTER THOROUGHFARE PLAN ARE AVAILABLE FROM THE DEPARTMENT OF PUBLIC WORKS, TRAFFIC DIVISION UPON REQUEST. EXCEPTIONS TO THIS PROVISION MAY BE REQUESTED FROM THE DIRECTOR OF PUBLIC WORKS OR HIS DESIGNATED AGENT.
- ELECTRONIC PORTABLE CHANGEABLE MESSAGE SIGNS (PCMS), MEETING THE REQUIREMENTS OF PART VI, SECTION 6F-2 OF THE LATEST EDITION OF THE TEXAS MANUAL ON UNIFORM TRAFFIC CONTROL DEVICES FOR STREETS AND HIGHWAYS SHALL BE USED WHENEVER ANY PORTION OF A ROADWAY IS TO BE CLOSED TO TRAFFIC IN EITHER OR BOTH DIRECTIONS, AND AT ANY OTHER LOCATION OR SITUATION DESIGNATED ON THE TRAFFIC CONTROL PLAN. THE PCMS SHALL BE IN PLACE, PROGRAMMED AND IN OPERATION AT LEAST SEVEN (7) CALENDAR DAYS BEFORE THE ROADWAY CLOSING. THE PCMS SHALL BE MAINTAINED IN GOOD OPERATING CONDITION UNTIL APPROVED CONSTRUCTION BARRICADING AND SIGNING IS IN PLACE AND THE ROADWAY IS ACTUALLY CLOSED TO TRAFFIC. THE DEPARTMENT OF PUBLIC WORKS. TRAFFIC DIVISION WILL ASSIST THE CONTRACTOR IN THE PREPARATION OF AND SHALL APPROVE THE MESSAGE(S) TO BE DISPLAYED BY THE
- NO WORK SHALL COMMENCE WITHIN EXISTING STREET RIGHT-OF-WAY WITHOUT AN APPROVED TRAFFIC CONTROL PLAN. THE CONTRACTOR SHALL NOTIFY THE CITY AT LEAST TWO (2) BUSINESS DAYS PRIOR TO BEGINNING WORK WITHIN THE RIGHT-OF-WAY, OR BEFORE PERFORMING ANY WORK WHICH WILL OBSTRUCT OR IMPEDE THE NORMAL FLOW OF TRAFFIC.
- 6. THE CONTRACTOR SHALL MAINTAIN ACCESS TO ALL CROSS STREETS (NON-PAY ITEM).

LEGEND

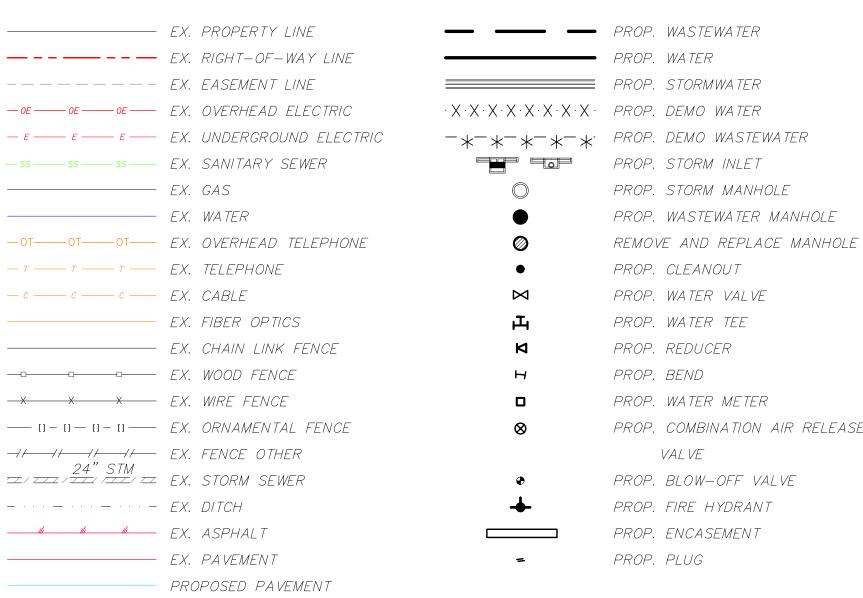

~~~~~~ WETLAND RESTRICTION ZONE - A A A A A A A A 100yr FLOODPLAIN BOUNDARY

> EX. TRANSMISSION TOWER EX. ELECTRICAL TRANSFORMER BOX

EX. ELECTRICAL POWER BOX EX. ELECTRIC MANHOLE

EX. TRAFFIC SIGNAL POWER BOX EX. POWER POLE

EX. ELECTRIC METER

EX. LIGHT POLE EX. DOWN GUY AND ANCHOR

EX. TELEPHONE MANHOLE EX. TELEPHONE PEDESTAL EX. TELEPHONE PEDESTAL

EX. TELEPHONE HAND HOLE EX. FIBER OPTIC VAULT EX. FIBER OPTIC MANHOLE

EX. FIBER OPTIC HANDHOLE EX. WATER FIRE HYDRANT EX. WATER MANHOLE

EX. WATER VALVE EX. WATER METER

EX. WATER VAULT EX. WASTE WATER MANHOLE

FX. CLEAN OUT EX. WASTE WATER VALVE

EX. WASTE WATER VAULT EX. GAS VENT EX. GAS METER EX. GAS TRANSFORMER

UTILITY CONTINUITY END OF UTILITY LINE SURVEY CONTROL POINT

TEMPORARY PAVEMENT REPAIR

PERMANENT PAVEMENT REPAIR

80210 12/2/2021

# Company Contact Phone and email

| COMPANY                | CONTACT          | PHONE                  | EMAIL                            |
|------------------------|------------------|------------------------|----------------------------------|
| AT&T                   | ROBERT ALDAPE    | 972-523-9415           | RA8642@ATT.COM                   |
| ATMOS MIDTEX           | RON HAYS         | 940-380-7479           | RON.HAYS@ATMOSENERGY.COM         |
| BRAZOS ELECTRIC TRANS  | TIM HARTZ        | 254-750-6761           | TIM.HERTZ@BRAZOSELECTRIC.COM     |
| CENTURYLINK (LEVEL 3)  | KEN HUCKABEE     | 469-426-4005           | KEN.HUCKABEE@CENTURYLINK.COM     |
| CHARTER-SPECTRUM       | ASHLEY SINGLETON | 469-426-4005           | ASHLEY.SINGLETON@CHARTER.COM     |
| CITY OF LEWISVILLE     | JEFFERY KELLY    | 972-219-3510           | JKELLY@CITYOFLEWISVILLE.COM      |
| TIME-WARNER CABLE      | JASON AYALA      | 817-298-3600           | JASON.AYALA@CHARTER.COM          |
| TEXAS-NEW MEXICO DIST  | CARLOS ESTRADIA  | 972-353-5050 EXT. 5006 | CARLOS.ESTRADIA@TNMP.COM         |
| UNITE PRIVATE NETWORKS | NICK OSULLIVAN   | 214-470-2710           | NICHOLAS.O'SULLIVAN@UPNFIBER.COM |
| VERIZON - FRONTIER     | MICHAEL GRAY     | 214-897-1749           | MICHAEL.D.GRAY@FTR.COM           |
| VERIZON BUSINESS MCI   | JEFF BUEHLER     | 469-886-4219           | JEFF.BUEHLER@VERIZON.COM         |

COMMENTS DATE CITY OF LEWISVILLE, TEXAS

ENGINEERING DEPARTMENT

FOX AVE. TO W. COLLEGE ST. GENERAL SHEETS



Texas Registered RJN GROUP, INC. F-3260

Engineering Firm 14755 PRESTON RD. SUITE 71 DALLAS, TEXAS 75254 SCALE | PROJECT NO. SHEET

DATE DESIGN: MDH DRAWN: PRR 18-3658-00 | 2 OF 74 CHECKED: JRC 2021 N.T.S



# SURVEYOR'S NOTES

- 1. THE COORDINATES AND DISTANCES ARE U.S. SURVEY FEET DISPLAYED IN SURFACE VALUES. THE SURFACE VALUES WERE CALCULATED BY MULTIPLYING THE GRID VALUES BY THE COMBINED TXDOT SCALE FACTOR FOR DENTON COUNTY 1.00015063.
- 2. THE HORIZONTAL COORDINATES ARE BASED ON TXDOT VIRTUAL REFERENCE STATIONS BASED ON THE TEXAS CORRDINATE SYSTEM, NORTH CENTRAL ZONE, NORTH AMERICAN DATUM OF 1983 (NAD 83) 2011 ADJUSTMENT, EPOCH 2010.00
- 3. THE VERTICAL CONTROL IS BASED ON TXDOT VIRTUAL REFERENCE STATIONS, NORTH AMERICAN VERTICAL DATUM OF 1988 (NAV 88) USING GEOID MODEL 12B.

## CONTROL POINTS:

CP #E0610139 - 8 INCH X 36 INCH CONCRETE

MARKER WITH TXDOT ALUMINUM CAP

LOCATED ON THE EAST SIDE OF IH-35E NORTH BOUND FEEDER ROAD APPROXIMATELY 615 FEET SOUTH FROM THE CENTERLINE OF HIGH SCOOL DRIVE AND 230 FEET NORTH FROM THE CENTERLINE OF FOX AVENUE.

SURFACE N=7065231.71

SURFACE E=2427819.63

GRID N=7064167.63

GRID E=2427453.99

ELEV.=541.54

CP #E0610149 - 8 INCH X 36 INCH CONCRETE

MARKER WITH TXDOT ALUMINUM CAP


LOCATED ON THE EAST SIDE OF IH-35E NORTH BOUND FEEDER ROAD APPROXIMATELY 45 FEET SOUTH FROM THE CENTERLINE OF PURNELL STREET AND 420 FEET NORTH FROM THE CENTERLINE OF CROCKETT DRIVE.


SURFACE N=7066289.98

SURFACE E=2426858.19

GRID N=7065225.74

GRID E=2426492.69 ELEV.=543.32

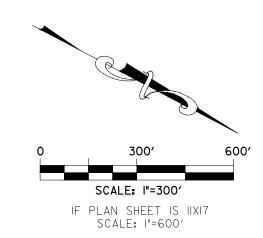

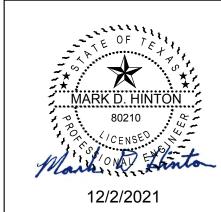

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CITY OF LEWISVILLE, TEXAS


ENGINEERING DEPARTMENT


FOX AVE. TO W. COLLEGE ST.

GENERAL SHEETS PROJECT LAYOUT

Texas Registered RJN GROUP, INC.
Engineering Firm 14755 PRESTON RD. SUITE 710
F-3260 DALLAS, TEXAS 75254

| DATE | SCALE | PROJECT NO. | SHEET             |
|------|-------|-------------|-------------------|
| Dec  | AS    | 40.00=0.00  | 0 71              |
| 2021 | NOTED | 18-3658-00  | 3 OF <b>74</b>    |
|      | Dec   | Dec AS      | Dec AS 19.3659.00 |

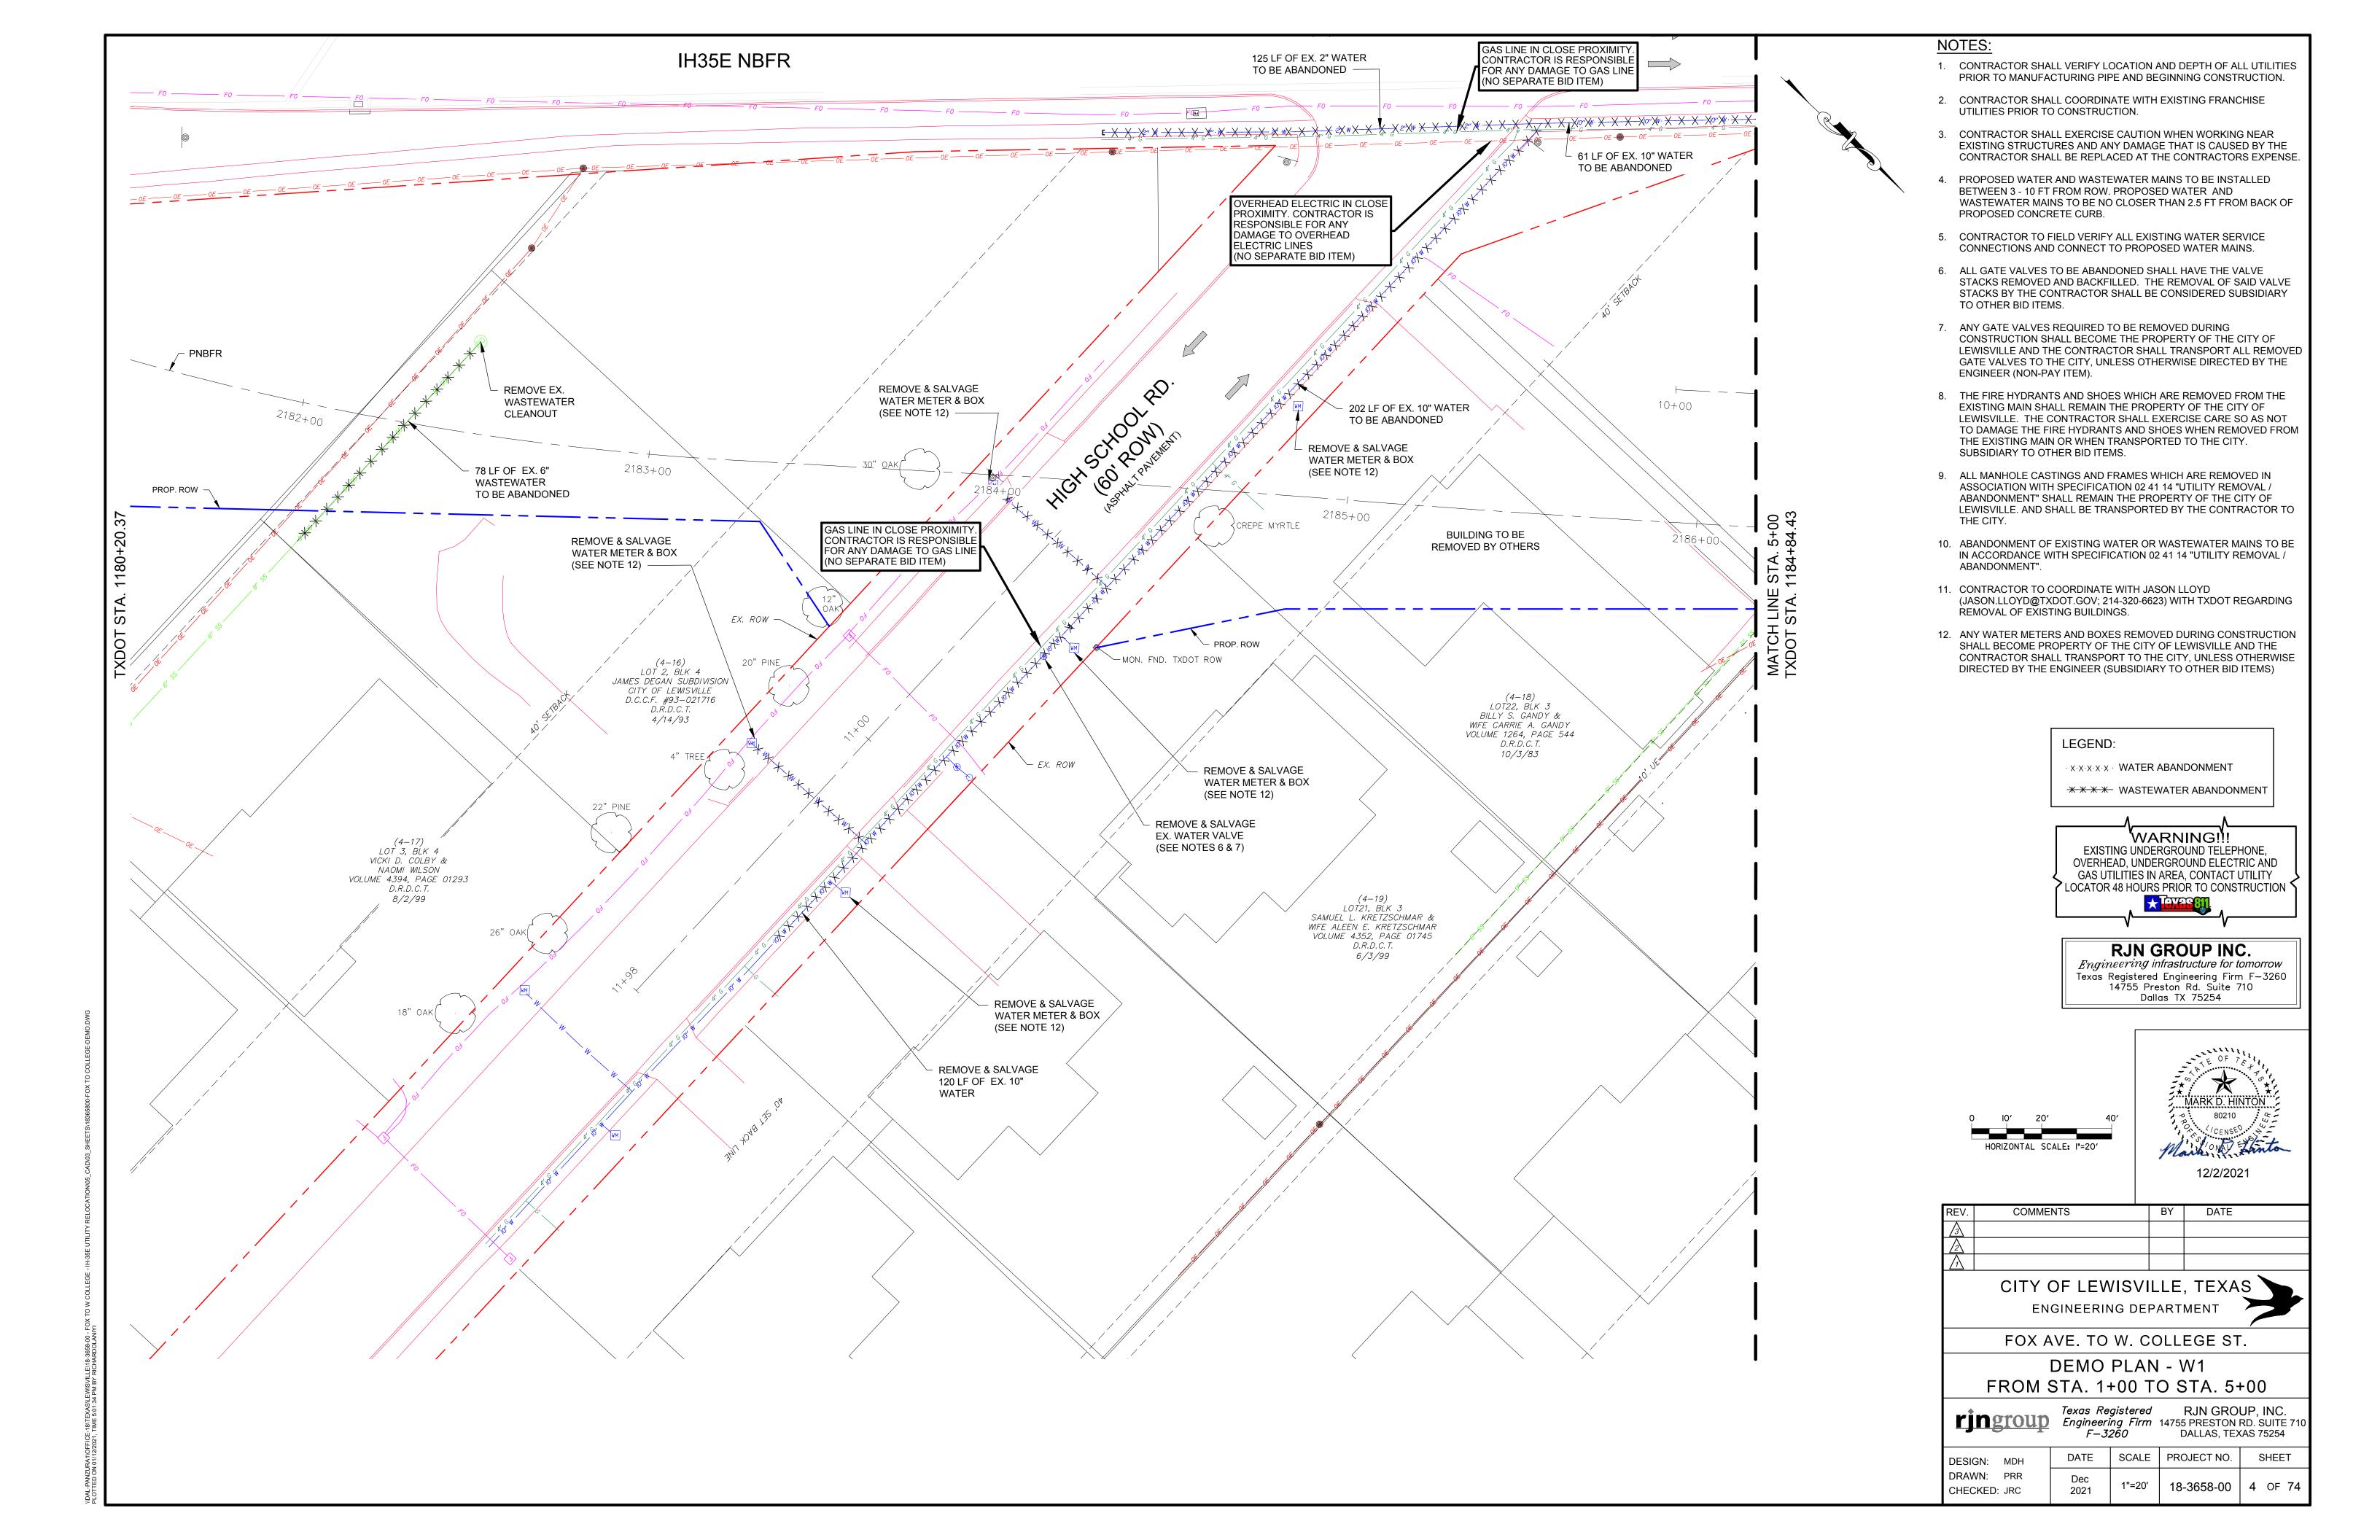

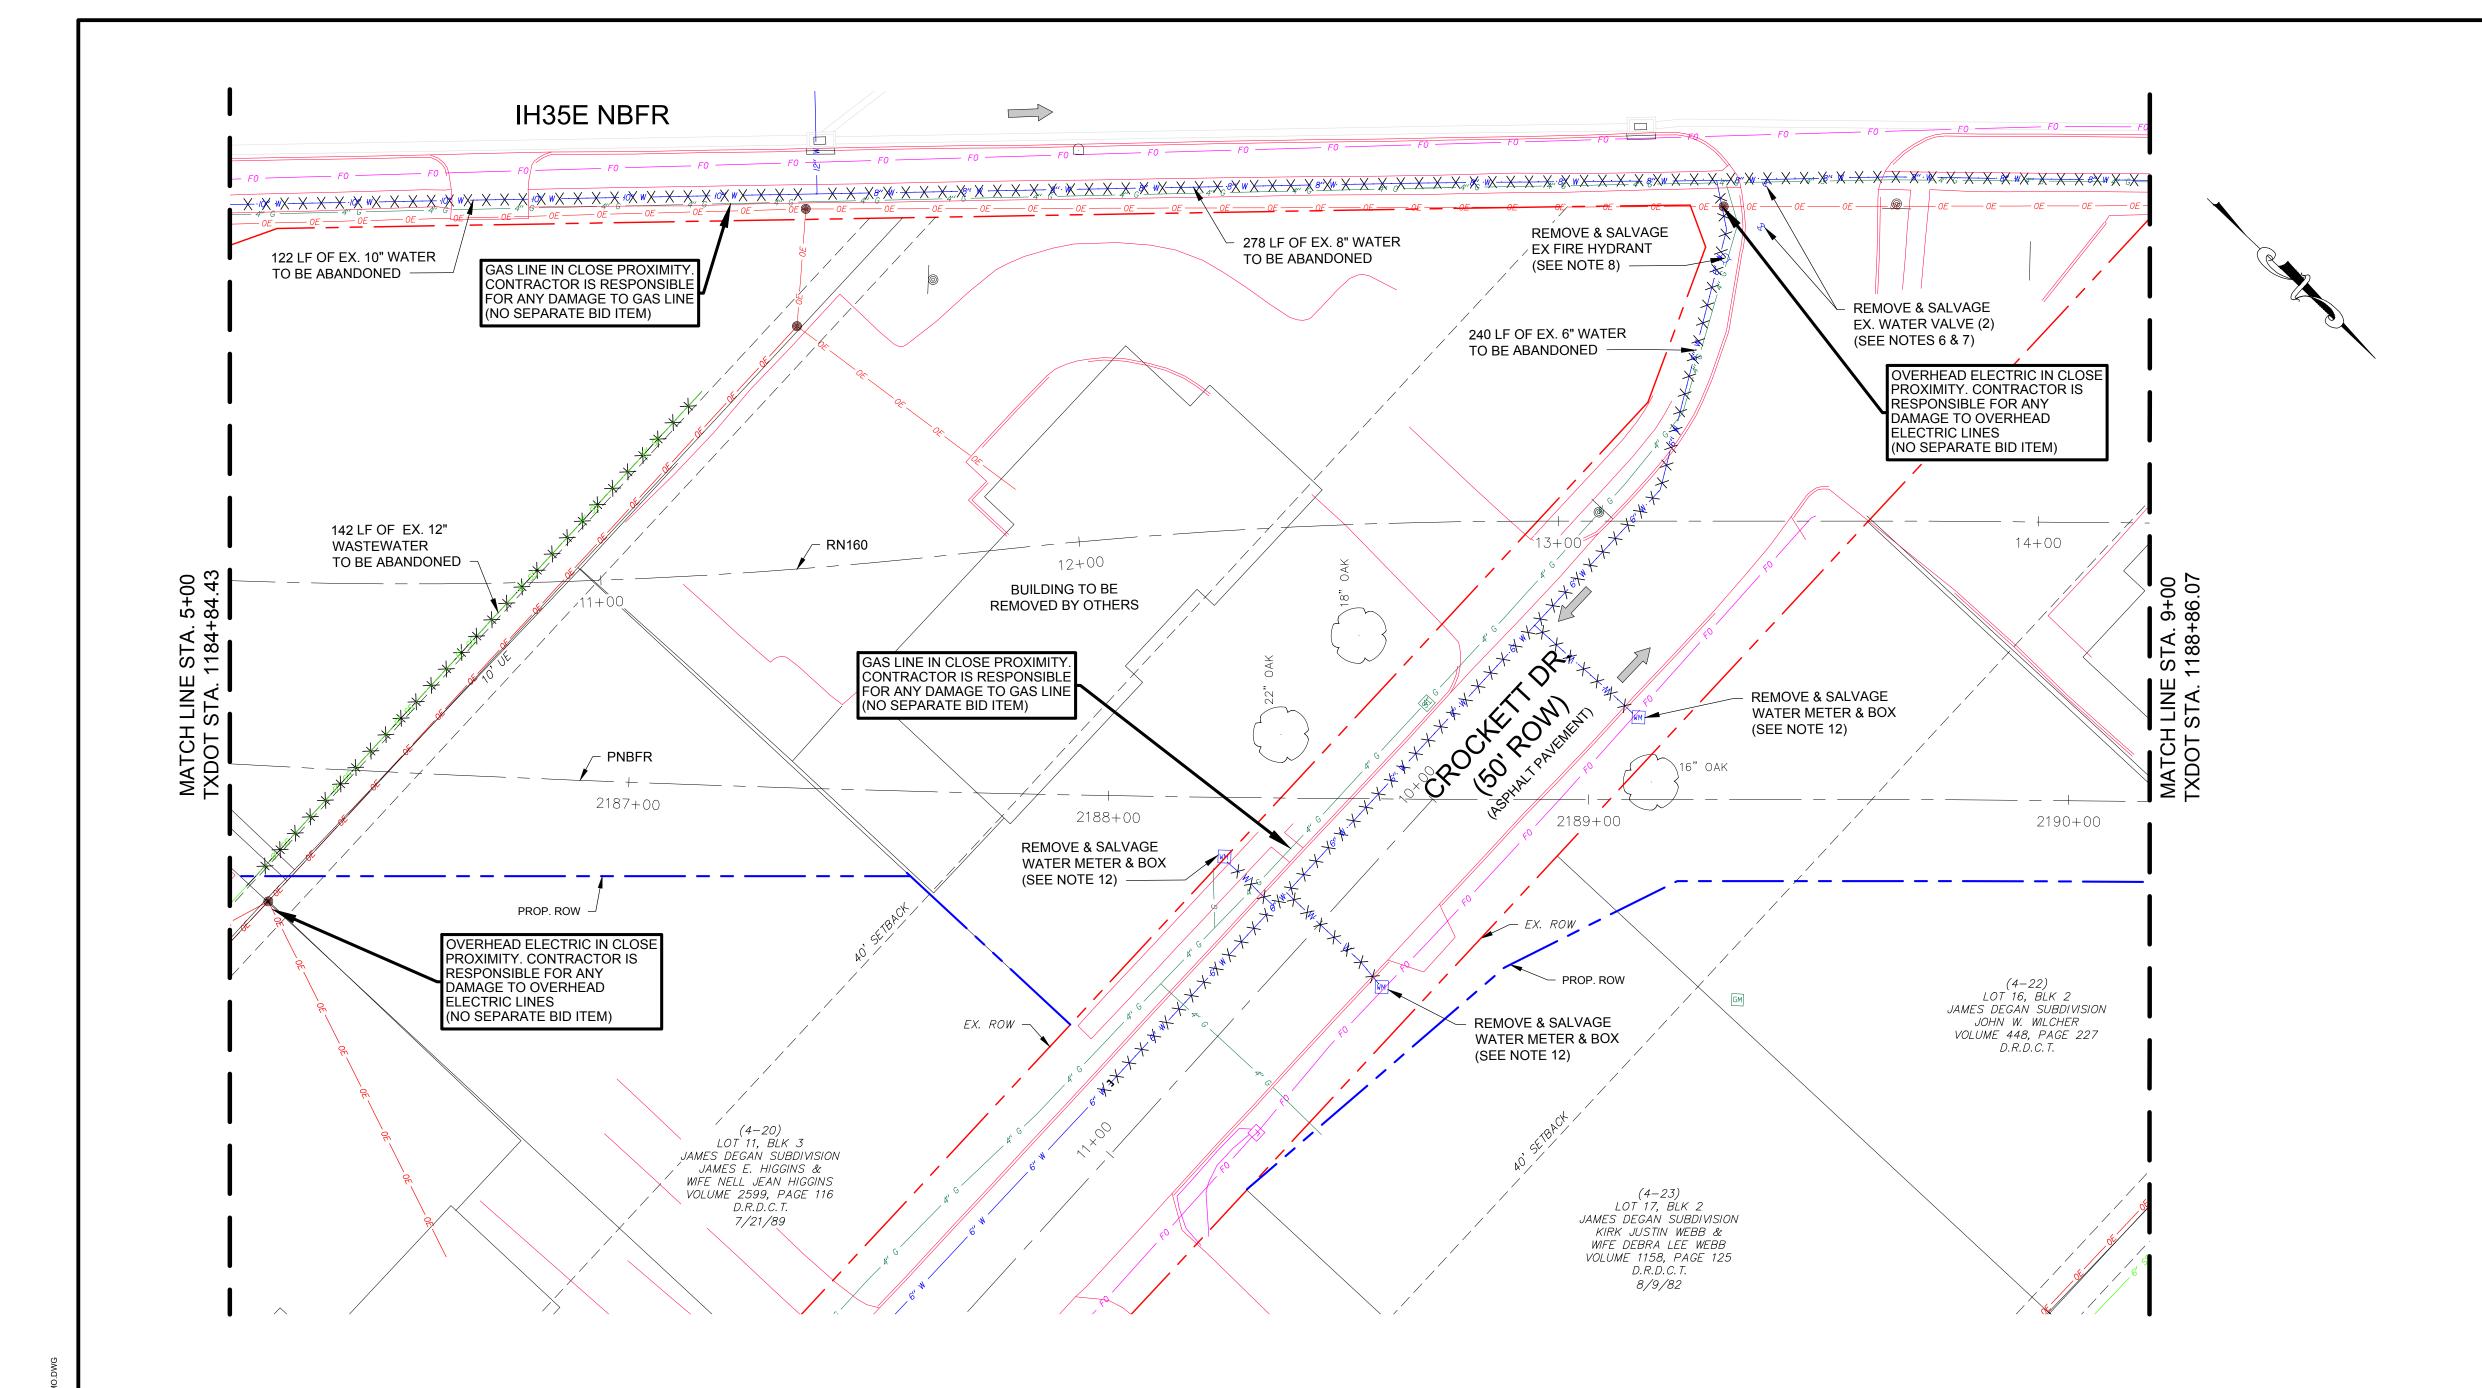

- 1. CONTRACTOR SHALL VERIFY LOCATION AND DEPTH OF ALL UTILITIES PRIOR TO MANUFACTURING PIPE AND BEGINNING CONSTRUCTION.
- 2. CONTRACTOR SHALL COORDINATE WITH EXISTING FRANCHISE UTILITIES PRIOR TO CONSTRUCTION.
- 3. CONTRACTOR SHALL EXERCISE CAUTION WHEN WORKING NEAR EXISTING STRUCTURES AND ANY DAMAGE THAT IS CAUSED BY THE CONTRACTOR SHALL BE REPLACED AT THE CONTRACTORS EXPENSE
- 4. PROPOSED WATER AND WASTEWATER MAINS TO BE INSTALLED BETWEEN 3 - 10 FT FROM ROW. PROPOSED WATER AND WASTEWATER MAINS TO BE NO CLOSER THAN 2.5 FT FROM BACK OF PROPOSED CONCRETE CURB.
- 5. CONTRACTOR TO FIELD VERIFY ALL EXISTING WATER SERVICE CONNECTIONS AND CONNECT TO PROPOSED WATER MAINS.
- 6. ALL GATE VALVES TO BE ABANDONED SHALL HAVE THE VALVE STACKS REMOVED AND BACKFILLED. THE REMOVAL OF SAID VALVE STACKS BY THE CONTRACTOR SHALL BE CONSIDERED SUBSIDIARY TO OTHER BID ITEMS.
- 7. ANY GATE VALVES REQUIRED TO BE REMOVED DURING CONSTRUCTION SHALL BECOME THE PROPERTY OF THE CITY OF LEWISVILLE AND THE CONTRACTOR SHALL TRANSPORT ALL REMOVED GATE VALVES TO THE CITY, UNLESS OTHERWISE DIRECTED BY THE ENGINEER (NON-PAY ITEM).
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- 9. ALL MANHOLE CASTINGS AND FRAMES WHICH ARE REMOVED IN ASSOCIATION WITH SPECIFICATION 02 41 14 "UTILITY REMOVAL / ABANDONMENT" SHALL REMAIN THE PROPERTY OF THE CITY OF LEWISVILLE. AND SHALL BE TRANSPORTED BY THE CONTRACTOR TO THE CITY.
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- 11. CONTRACTOR TO COORDINATE WITH JASON LLOYD (JASON.LLOYD@TXDOT.GOV; 214-320-6623) WITH TXDOT REGARDING REMOVAL OF EXISTING BUILDINGS.
- 12. ANY WATER METERS AND BOXES REMOVED DURING CONSTRUCTION SHALL BECOME PROPERTY OF THE CITY OF LEWISVILLE AND THE CONTRACTOR SHALL TRANSPORT TO THE CITY, UNLESS OTHERWISE DIRECTED BY THE ENGINEER (SUBSIDIARY TO OTHER BID ITEMS)

## LEGEND:


· X·X·X·X·X· WATER ABANDONMENT

\*\* \* \* \* WASTEWATER ABANDONMENT

WARNING!!! EXISTING UNDERGROUND TELEPHONE, OVERHEAD. UNDERGROUND ELECTRIC AND GAS UTILITIES IN AREA, CONTACT UTILITY LOCATOR 48 HOURS PRIOR TO CONSTRUCTION

# **RJN GROUP INC.**

Engineering infrastructure for tomorrow Texas Registered Engineering Firm F-3260 14755 Preston Rd. Suite 710 Dallas TX 75254

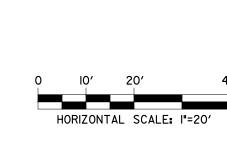



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CITY OF LEWISVILLE, TEXAS ENGINEERING DEPARTMENT

FOX AVE. TO W. COLLEGE ST.


DEMO PLAN - W1

FROM STA. 5+00 TO STA. 9+00



Texas Registered RJN GROUP, INC. Engineering Firm 14755 PRESTON RD. SUITE 710 DALLAS, TEXAS 75254

SCALE | PROJECT NO. SHEET DESIGN: MDH DRAWN: PRR 1"=20' 18-3658-00 | 5 OF 74 2021 CHECKED: JRC

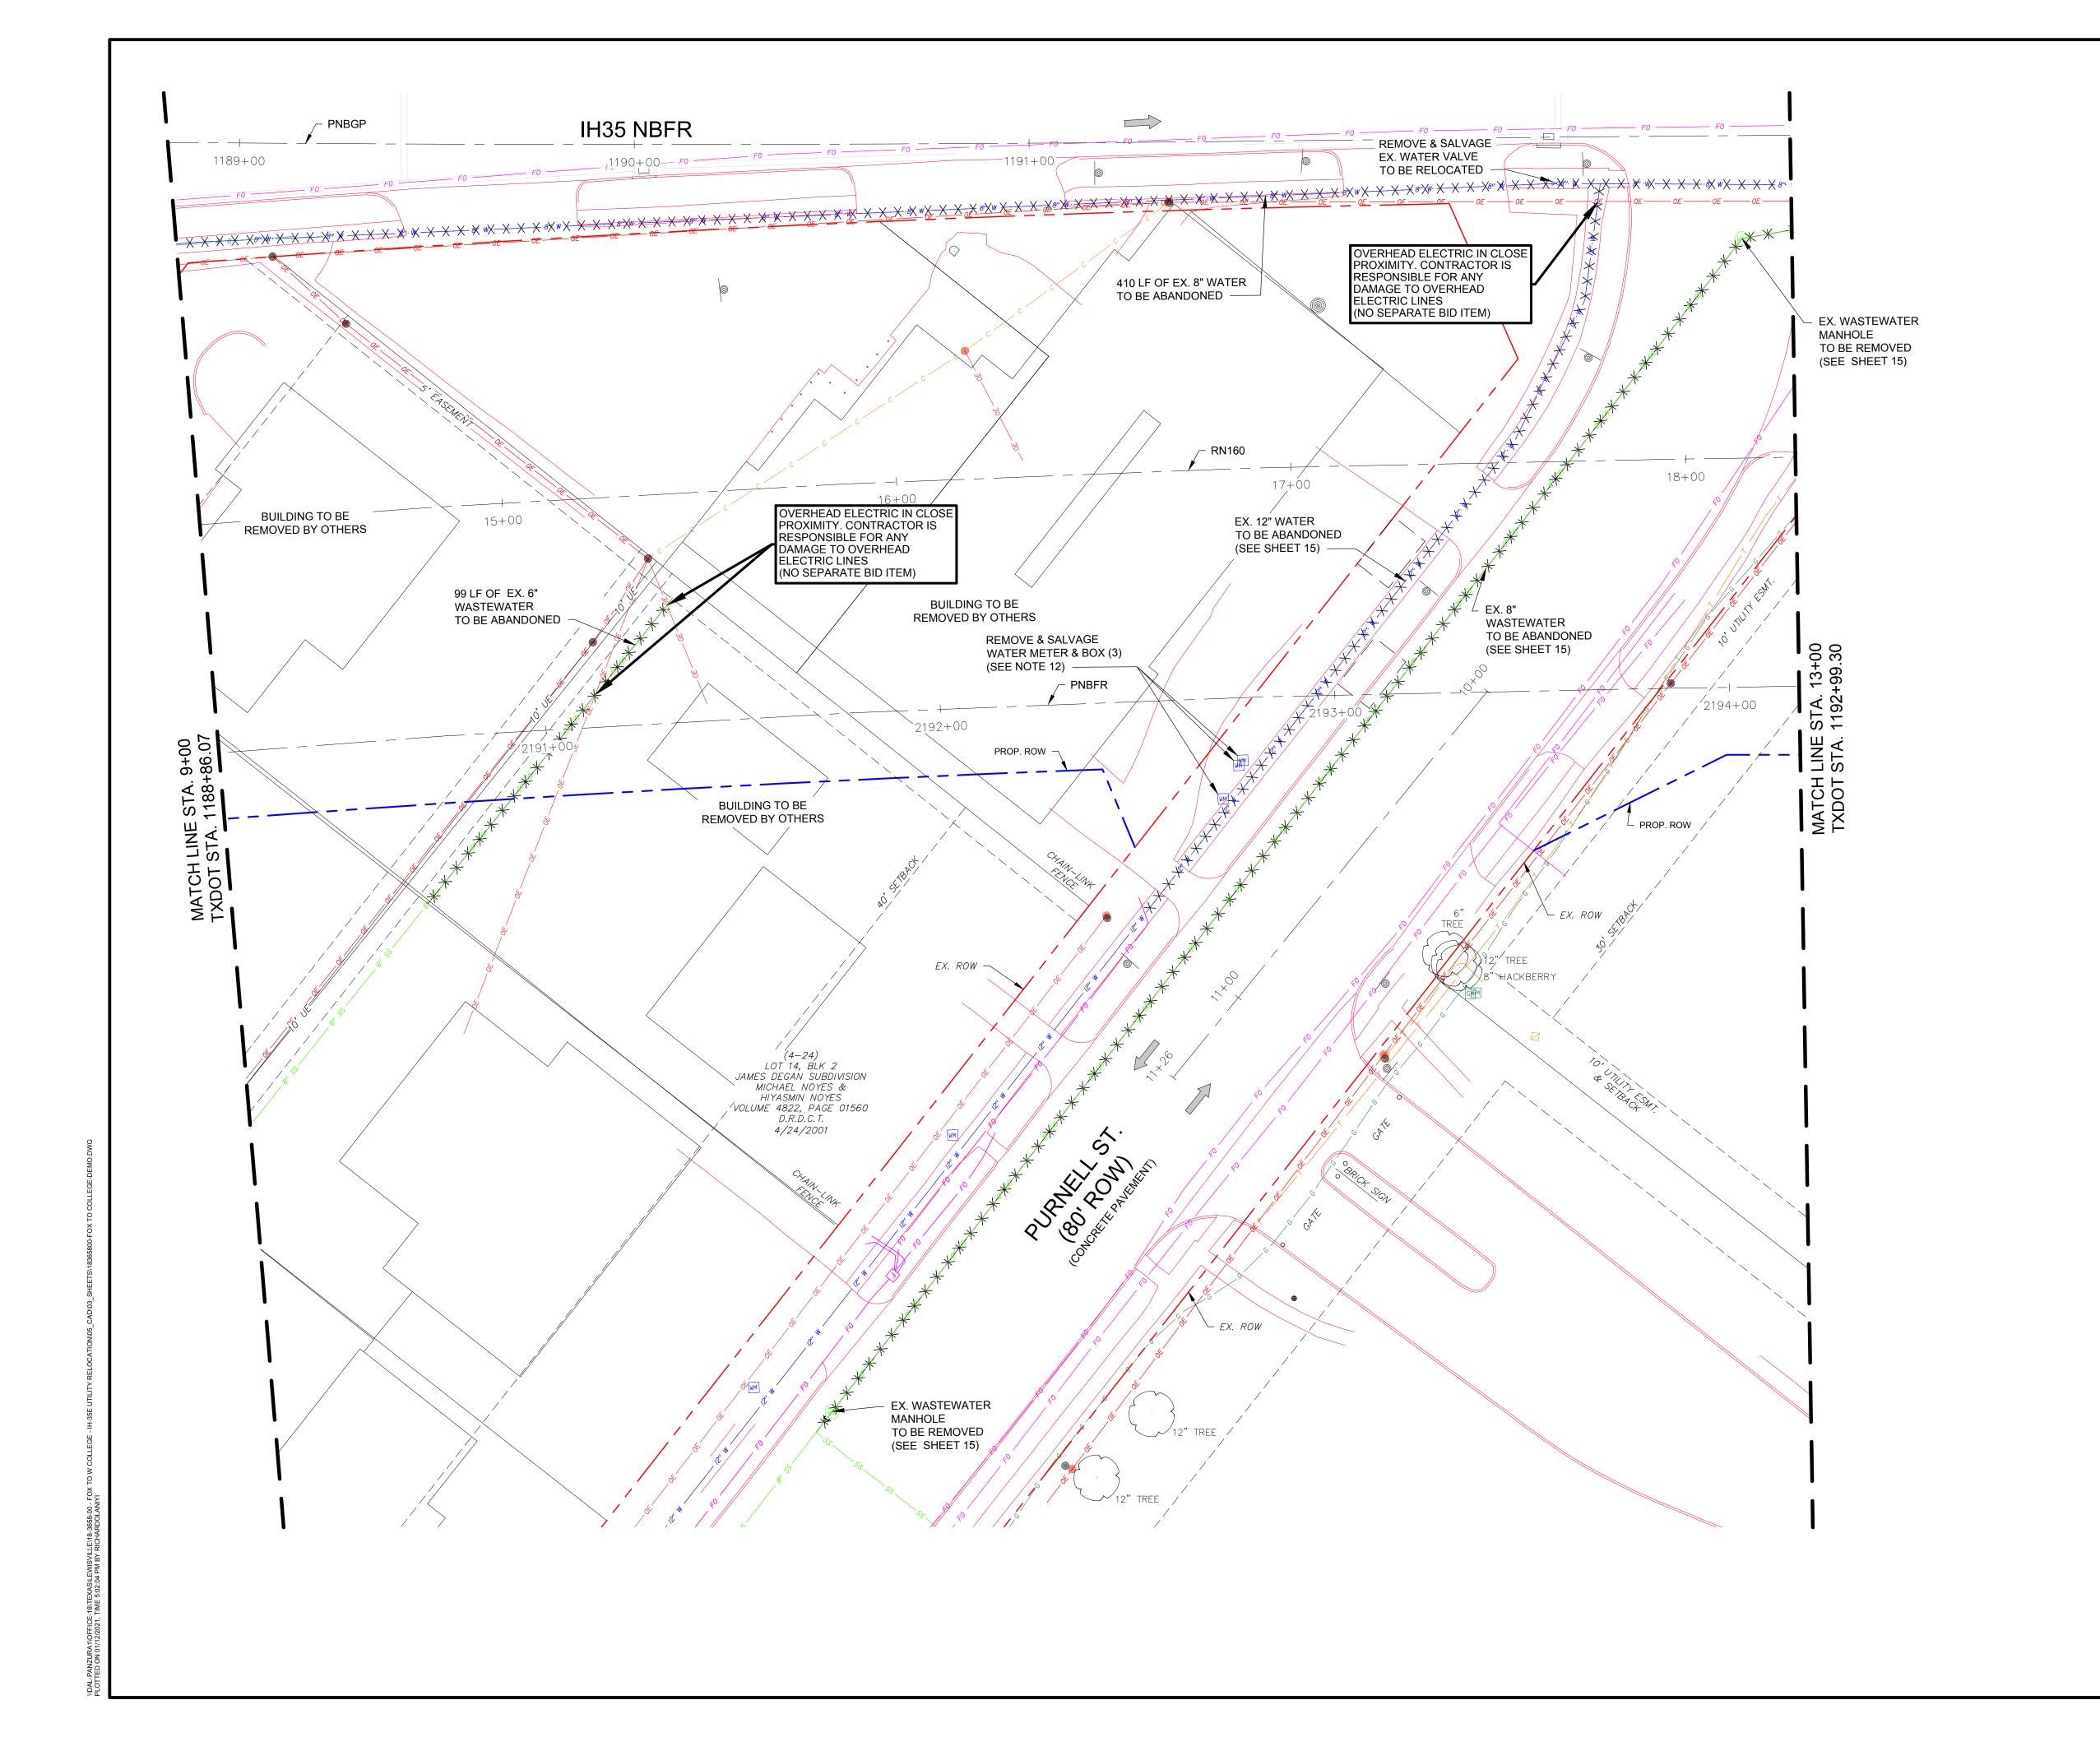

- 1. CONTRACTOR SHALL VERIFY LOCATION AND DEPTH OF ALL UTILITIES PRIOR TO MANUFACTURING PIPE AND BEGINNING CONSTRUCTION.
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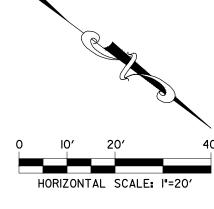
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# **RJN GROUP INC.**

Engineering infrastructure for tomorrow Texas Registered Engineering Firm F-3260 14755 Preston Rd. Suite 710 Dallas TX 75254





12/2/2021

|             | CITY OF LEWISVI | LLE | . TEXAS |
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ENGINEERING DEPARTMENT

FOX AVE. TO W. COLLEGE ST.

DEMO PLAN - W1

FROM STA. 9+00 TO STA. 13+00




Texas Registered RJN GROUP, INC.


Engineering Firm 14755 PRESTON RD. SUITE 710

F-3260 DALLAS, TEXAS 75254

SCALE | PROJECT NO. SHEET DESIGN: MDH DRAWN: PRR Dec 2021 1"=20' 18-3658-00 | 6 OF 74 CHECKED: JRC

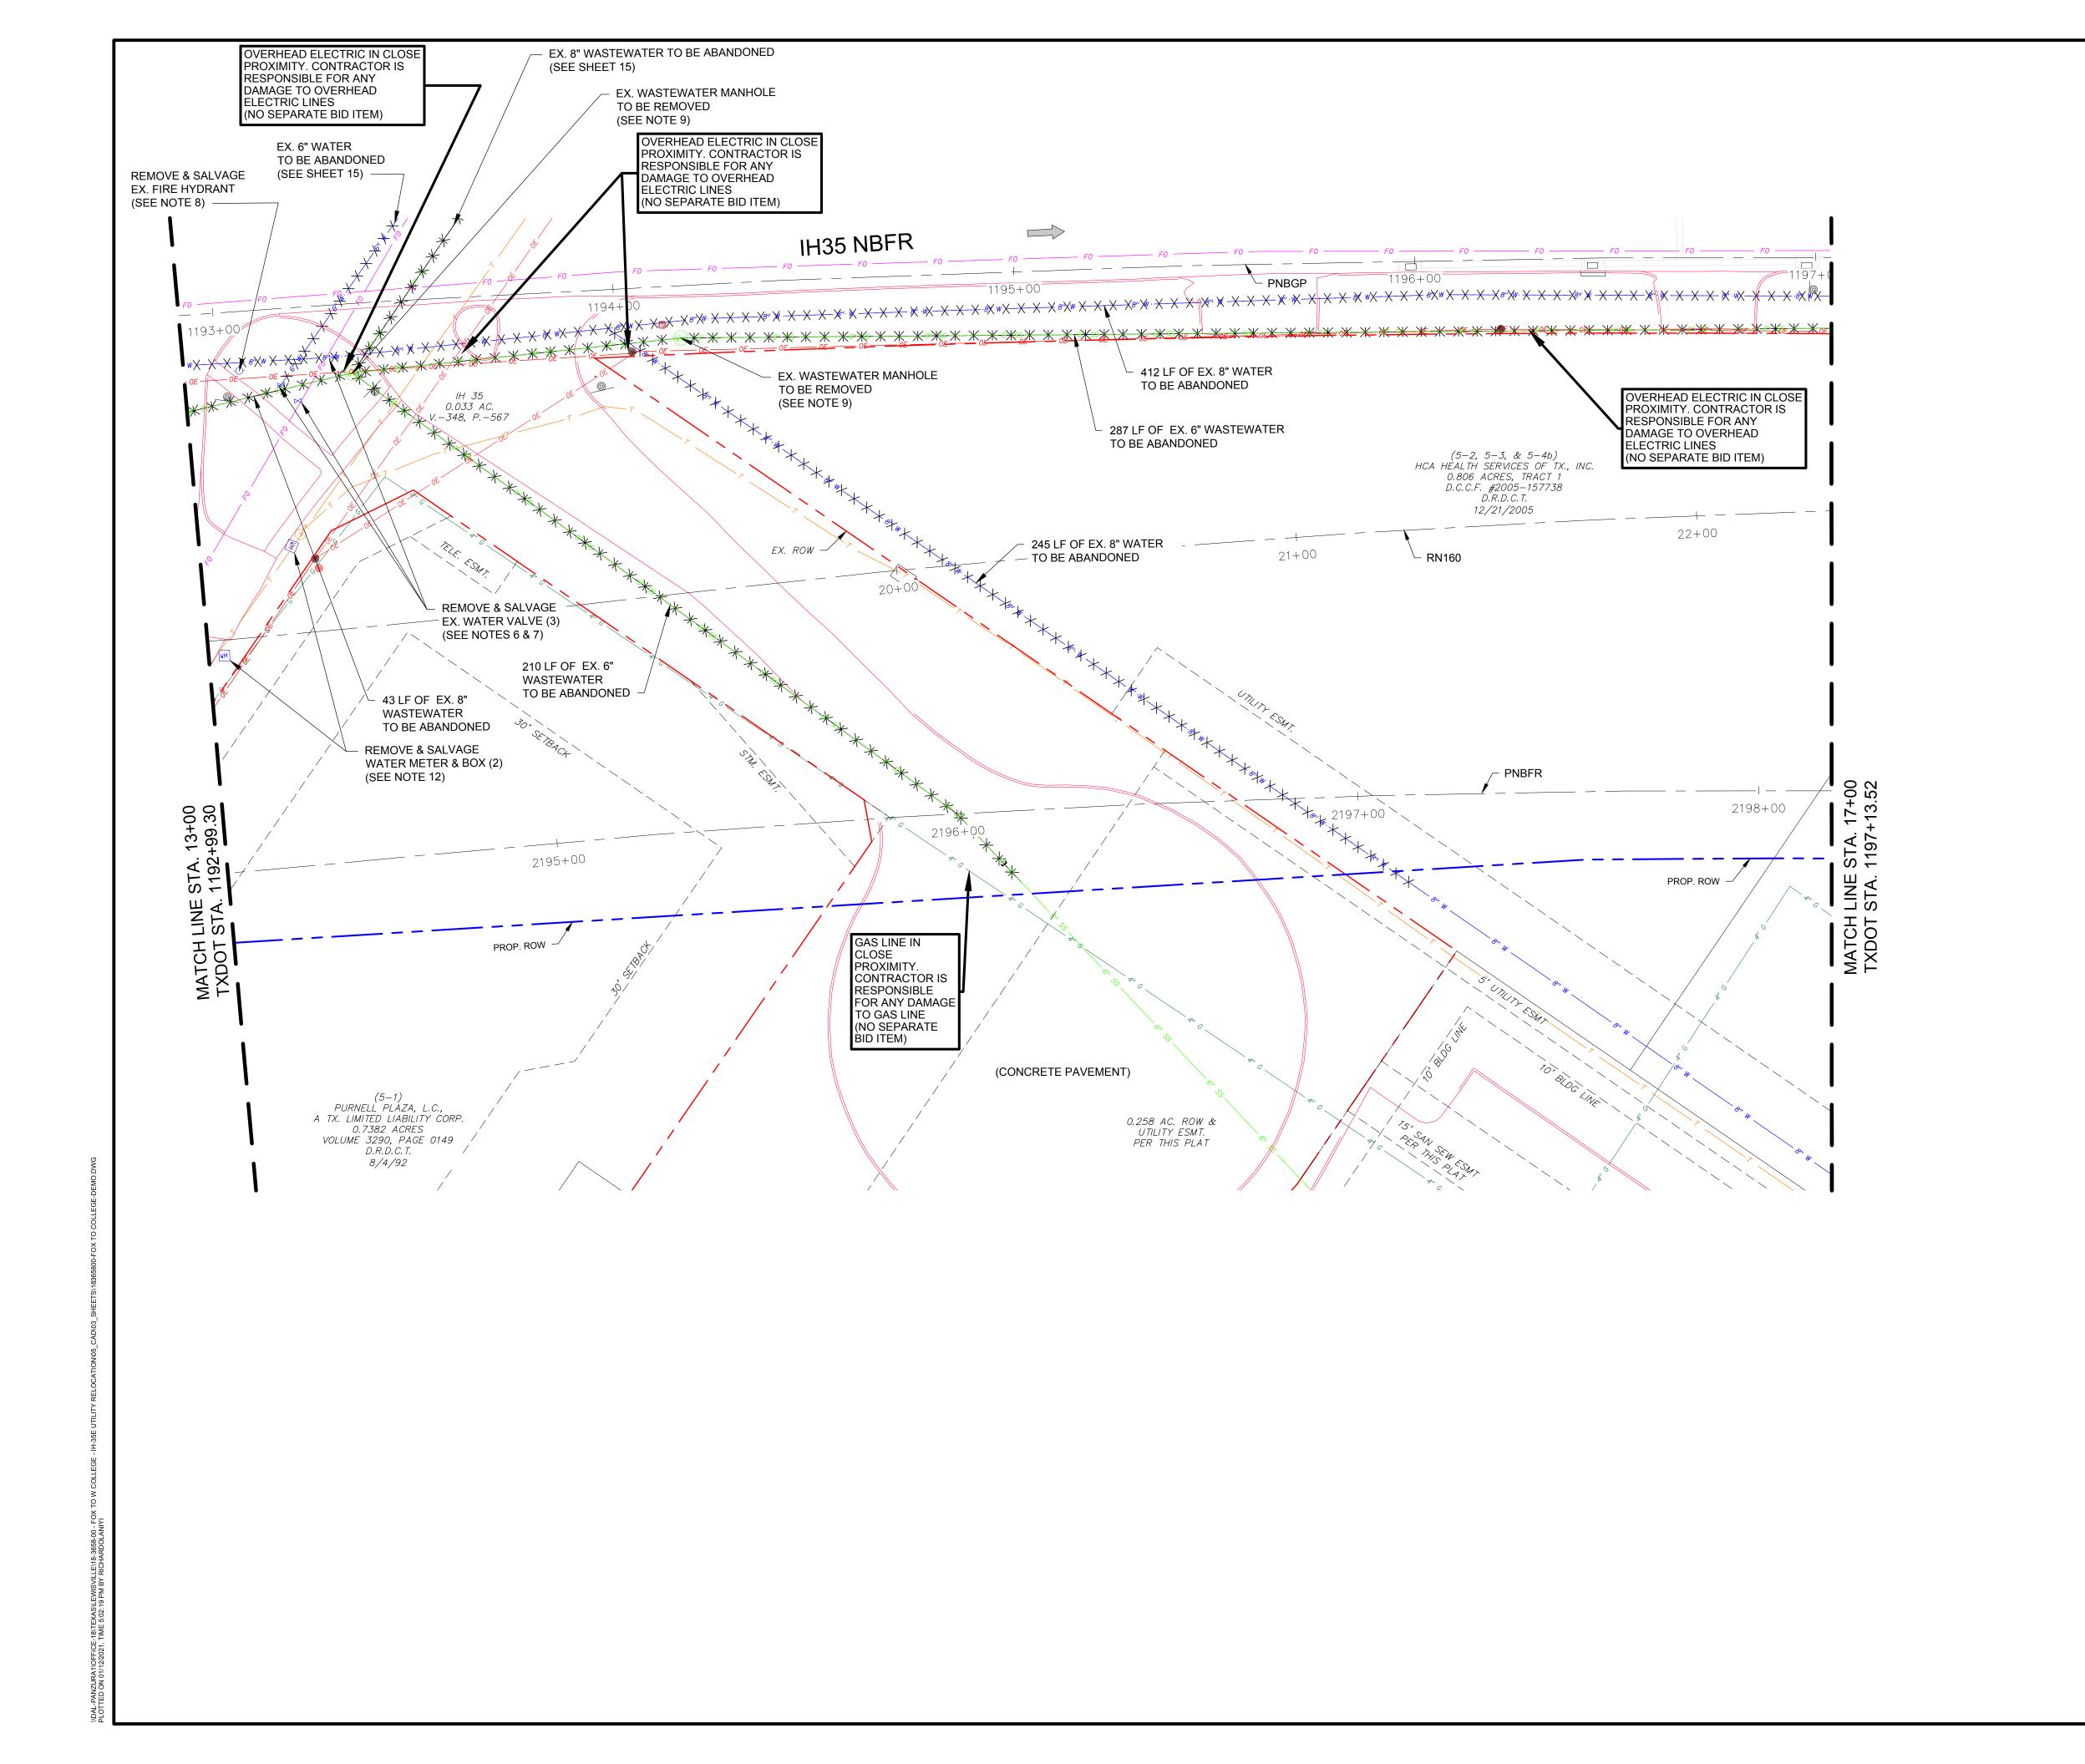


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- 12. ANY WATER METERS AND BOXES REMOVED DURING CONSTRUCTION SHALL BECOME PROPERTY OF THE CITY OF LEWISVILLE AND THE CONTRACTOR SHALL TRANSPORT TO THE CITY, UNLESS OTHERWISE DIRECTED BY THE ENGINEER (SUBSIDIARY TO OTHER BID ITEMS)

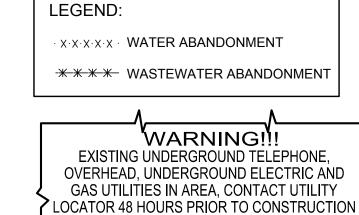

# **RJN GROUP INC.**

Engineering infrastructure for tomorrow Texas Registered Engineering Firm F−3260 14755 Preston Rd. Suite 710 Dallas TX 75254

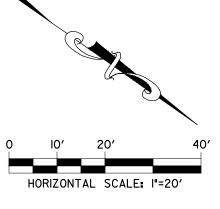



12/2/2021

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FOX AVE. TO W. COLLEGE ST.


ENGINEERING DEPARTMENT

DEMO PLAN - W1 FROM STA. 13+00 TO STA. 17+00



Texas Registered RJN GROUP, INC. Engineering Firm 14755 PRESTON RD. SUITE 710 DALLAS, TEXAS 75254

SCALE | PROJECT NO. SHEET DESIGN: MDH DRAWN: PRR 1"=20' 18-3658-00 7 OF 74 2021 CHECKED: JRC

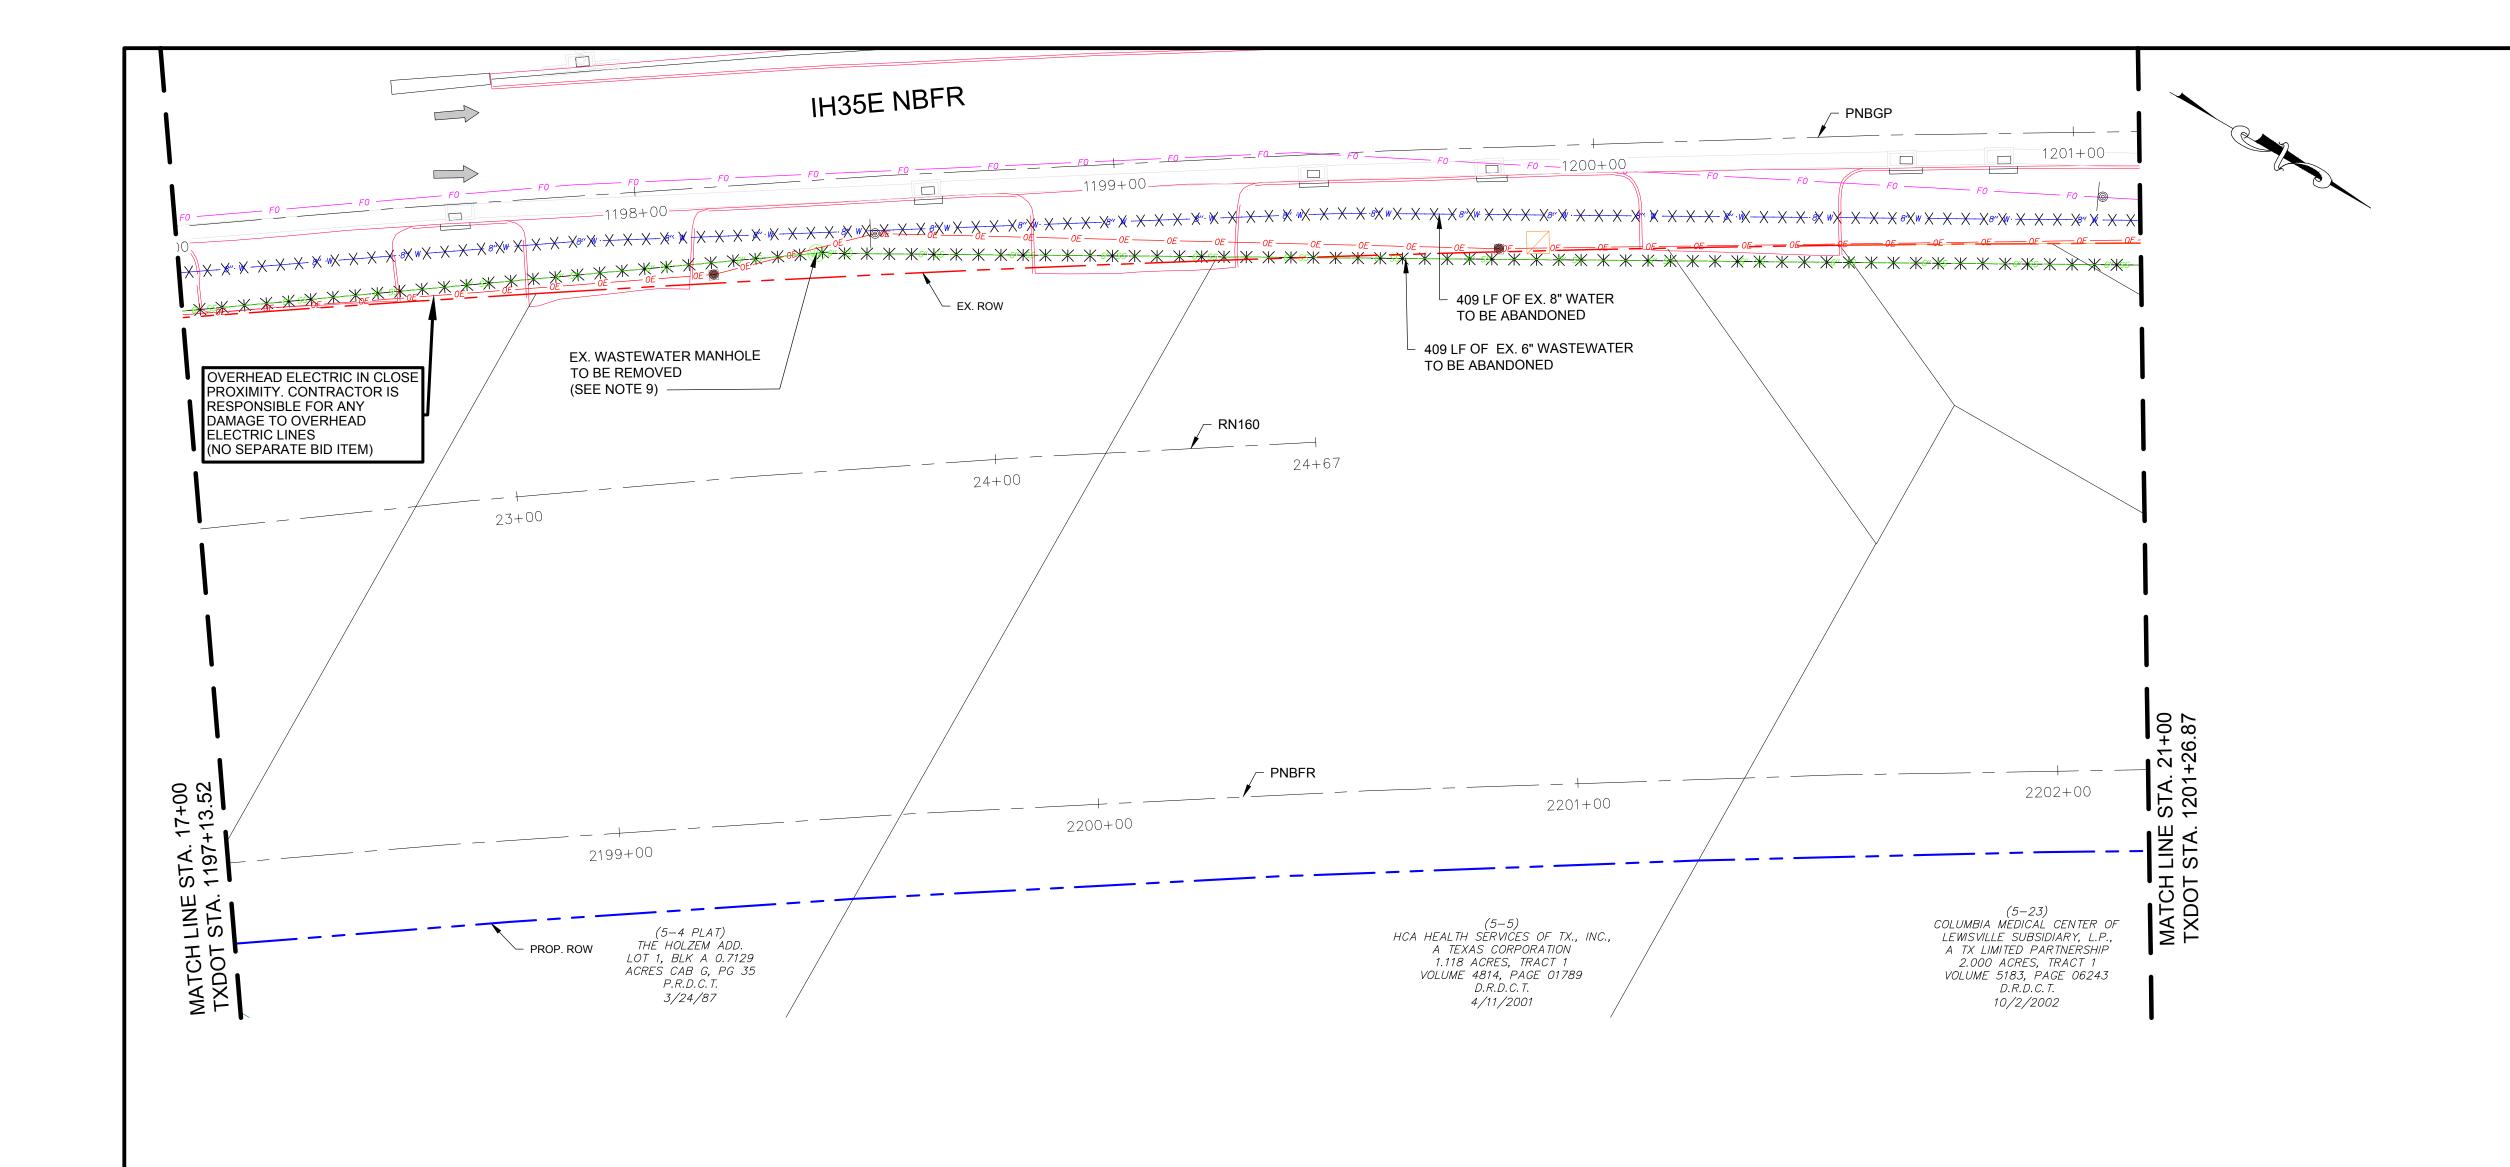

- 1. CONTRACTOR SHALL VERIFY LOCATION AND DEPTH OF ALL UTILITIES PRIOR TO MANUFACTURING PIPE AND BEGINNING CONSTRUCTION.
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#### LEGEND:


· X·X·X·X·X· WATER ABANDONMENT

\*\* \* \* \* WASTEWATER ABANDONMENT

WARNING!!! EXISTING UNDERGROUND TELEPHONE, OVERHEAD, UNDERGROUND ELECTRIC AND GAS UTILITIES IN AREA, CONTACT UTILITY LOCATOR 48 HOURS PRIOR TO CONSTRUCTION

# **RJN GROUP INC.**

Engineering infrastructure for tomorrow Texas Registered Engineering Firm F-3260 14755 Preston Rd. Suite 710 Dallas TX 75254

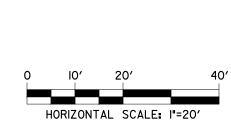



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CITY OF LEWISVILLE, TEXAS ENGINEERING DEPARTMENT

FOX AVE. TO W. COLLEGE ST.


DEMO PLAN - W1

FROM STA. 17+00 TO STA. 21+00



Texas Registered RJN GROUP, INC. Engineering Firm 14755 PRESTON RD. SUITE 710 DALLAS, TEXAS 75254

SCALE | PROJECT NO. SHEET DESIGN: MDH DRAWN: PRR Dec 2021 1"=20' 18-3658-00 | 8 OF 74 CHECKED: JRC

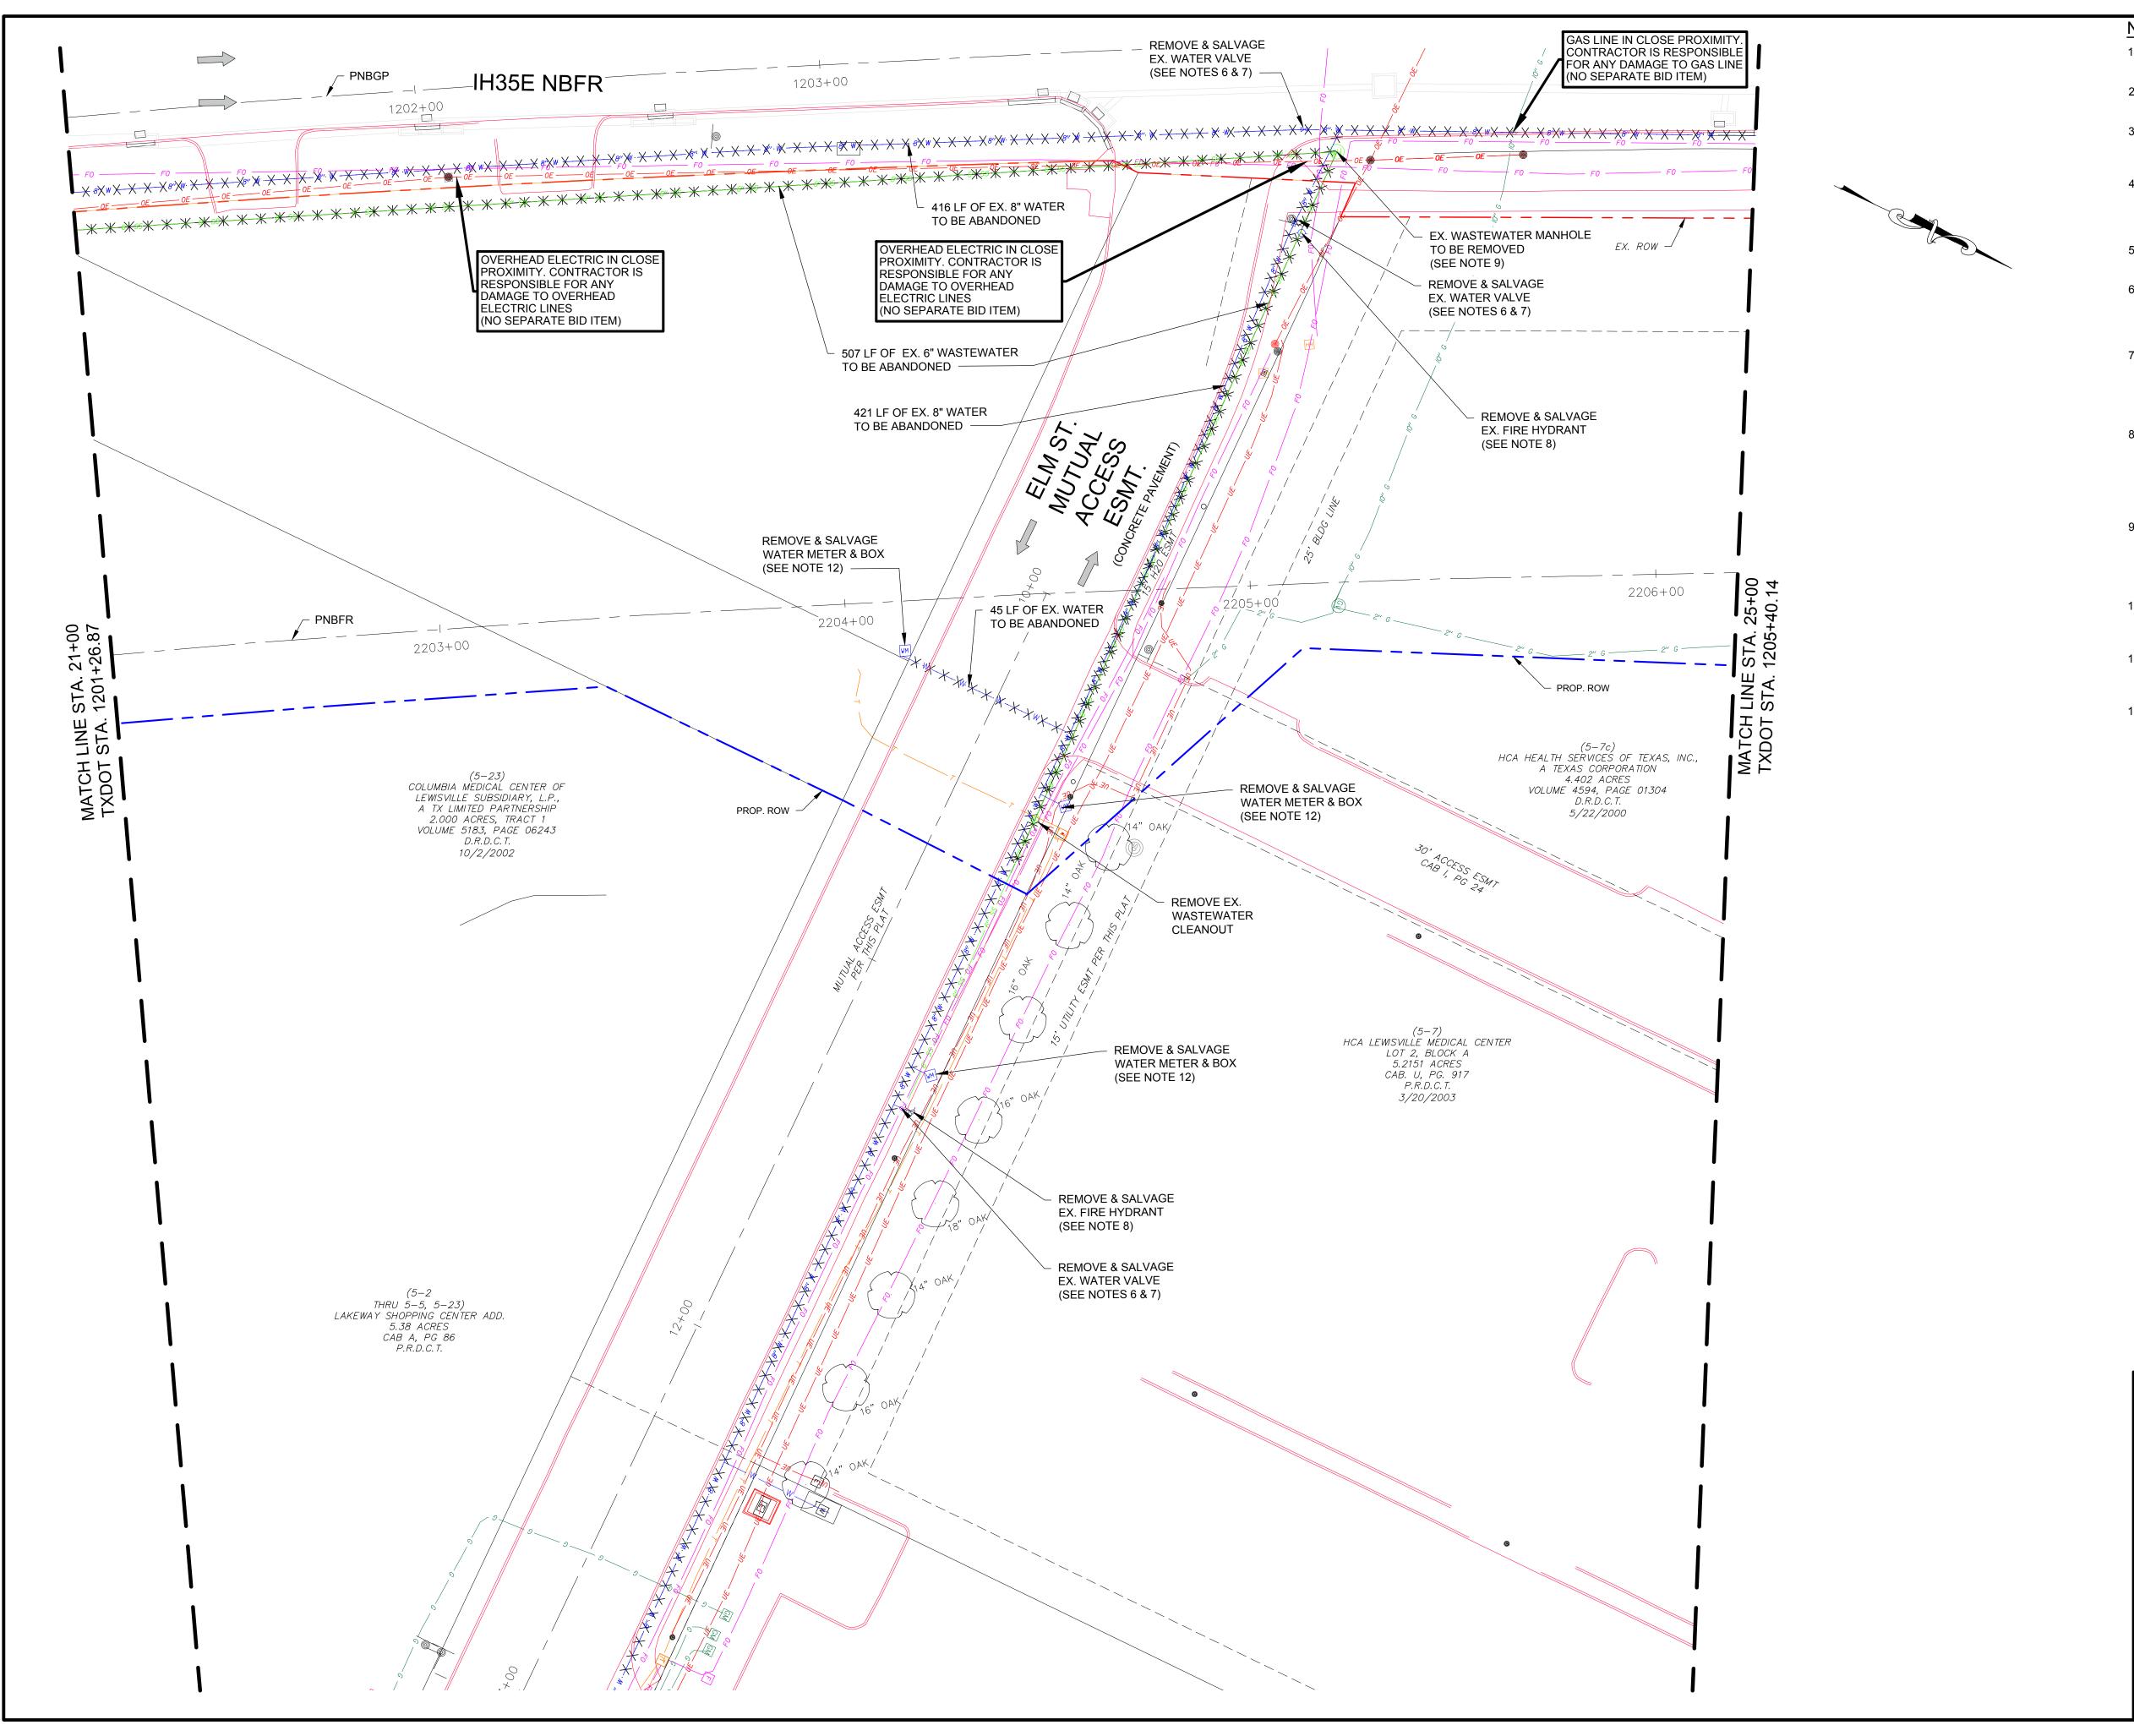

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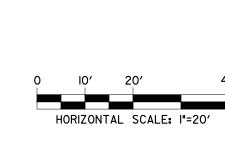
· X·X·X·X·X·X · WATER ABANDONMENT

\*\* \* \* \* WASTEWATER ABANDONMENT

WARNING!!! EXISTING UNDERGROUND TELEPHONE, OVERHEAD, UNDERGROUND ELECTRIC AND GAS UTILITIES IN AREA, CONTACT UTILITY LOCATOR 48 HOURS PRIOR TO CONSTRUCTION

# **RJN GROUP INC.**

Engineering infrastructure for tomorrow Texas Registered Engineering Firm F-3260 14755 Preston Rd. Suite 710 Dallas TX 75254



COMMENTS



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CITY OF LEWISVILLE, TEXAS

FOX AVE. TO W. COLLEGE ST.

ENGINEERING DEPARTMENT


DEMO PLAN - W1

FROM STA. 21+00 TO STA. 25+00



Texas Registered RJN GROUP, INC.
Engineering Firm 14755 PRESTON RD. SUITE 710 DALLAS, TEXAS 75254

SCALE | PROJECT NO. SHEET DESIGN: MDH DRAWN: PRR 1"=20' 18-3658-00 9 OF 74 2021 CHECKED: JRC

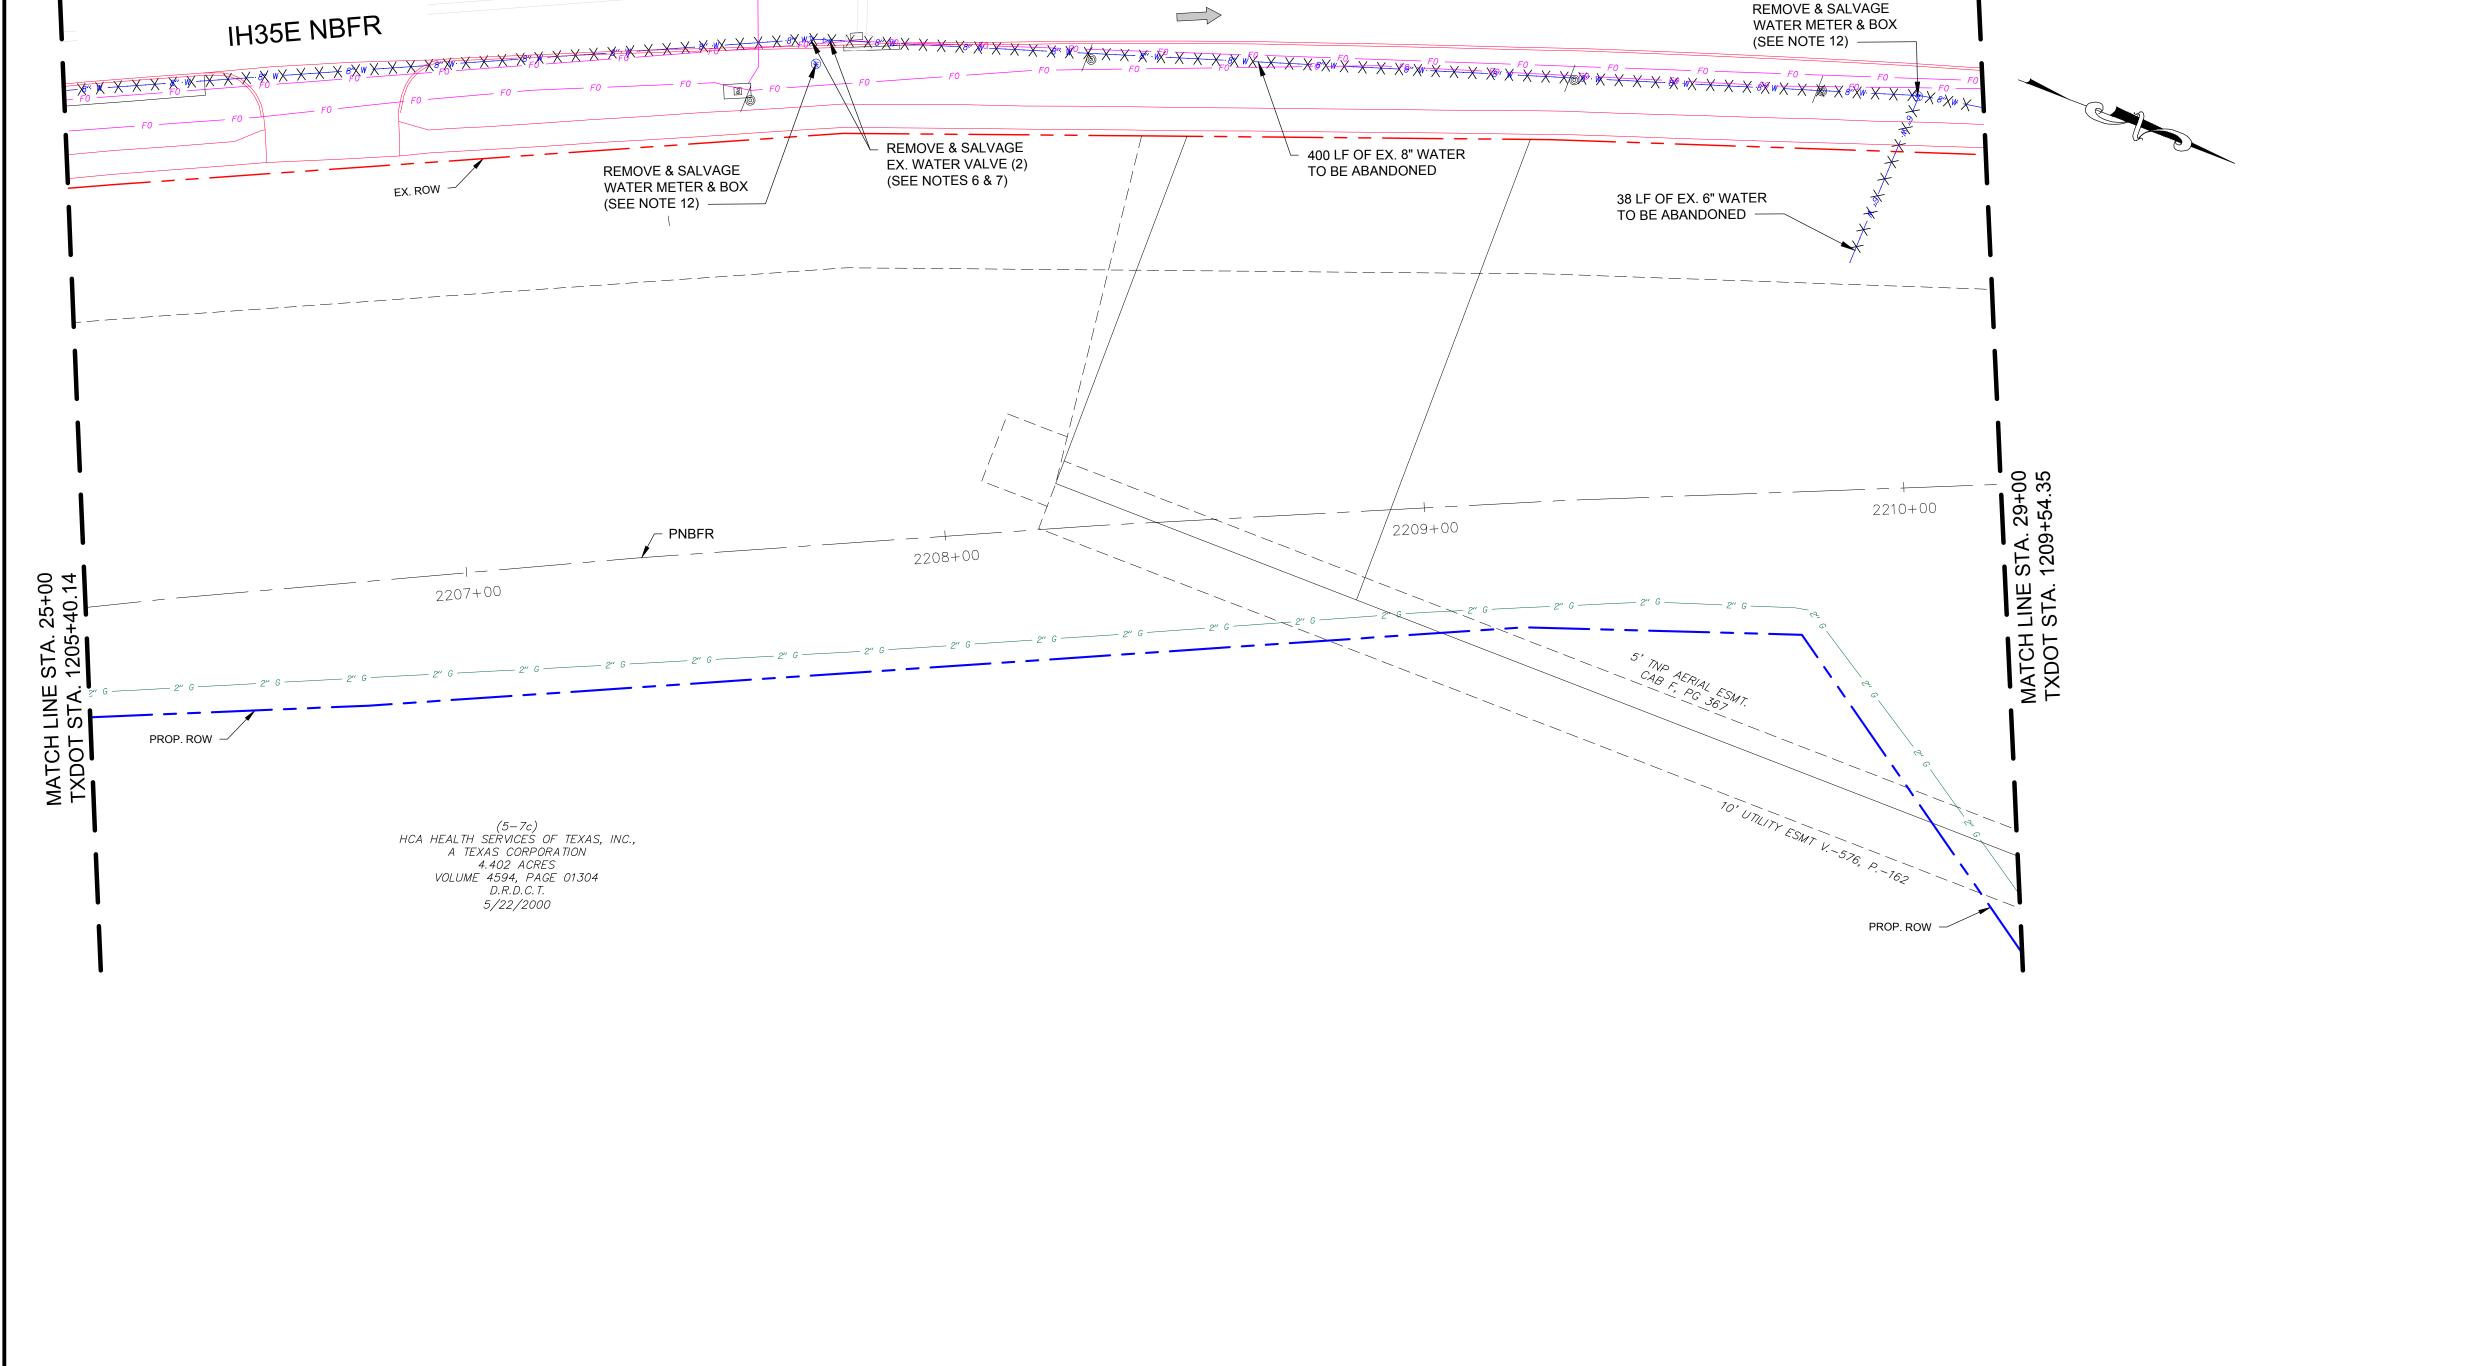

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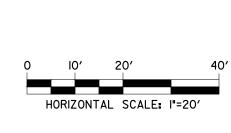
· X·X·X·X·X· WATER ABANDONMENT

\*\* \* \* \* WASTEWATER ABANDONMENT

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# **RJN GROUP INC.**

Engineering infrastructure for tomorrow Texas Registered Engineering Firm F-3260 14755 Preston Rd. Suite 710 Dallas TX 75254





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ENGINEERING DEPARTMENT

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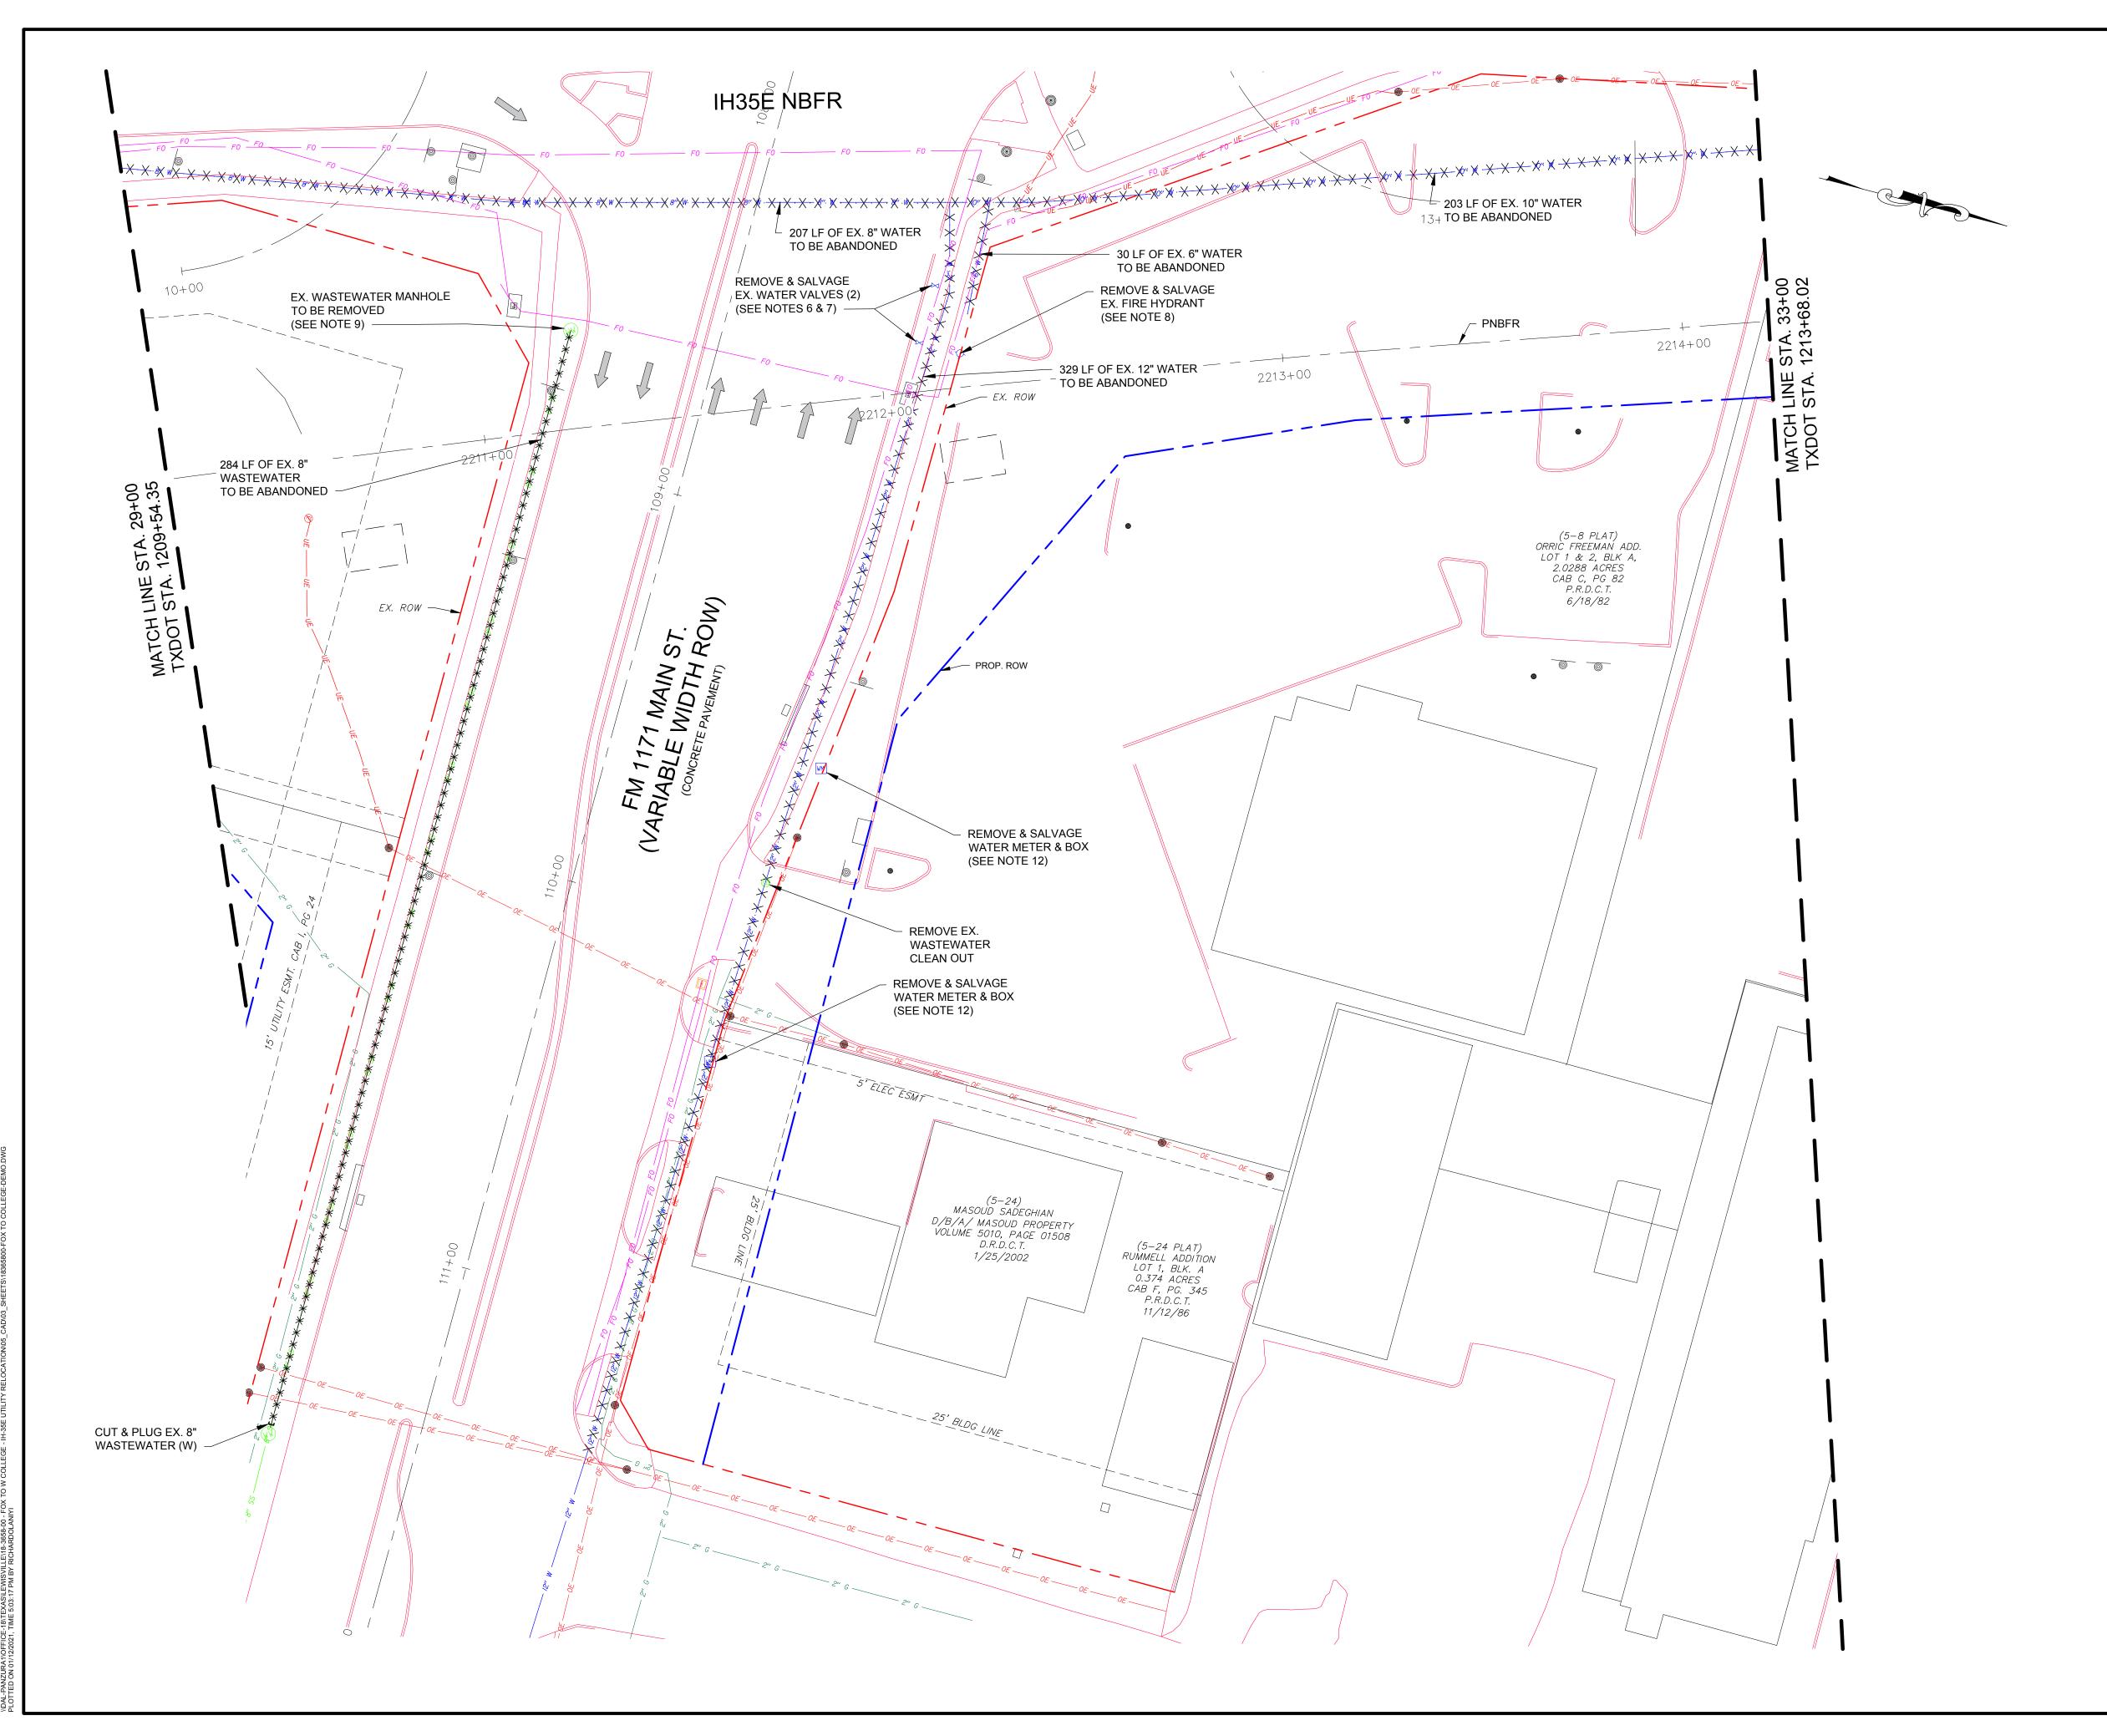
DEMO PLAN - W1

FROM STA. 25+00 TO STA. 29+00



Texas Registered RJN GROUP, INC.
Engineering Firm 14755 PRESTON RD. SUITE 710
F-3260 DALLAS, TEXAS 75254

SCALE | PROJECT NO. SHEET DESIGN: MDH DRAWN: PRR Dec 2021 18-3658-00 10 OF 74 1"=20' CHECKED: JRC



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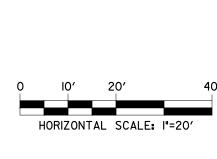
· X·X·X·X·X· WATER ABANDONMENT

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# **RJN GROUP INC.**

Engineering infrastructure for tomorrow Texas Registered Engineering Firm F-3260 14755 Preston Rd. Suite 710 Dallas TX 75254





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CITY OF LEWISVILLE, TEXAS ENGINEERING DEPARTMENT

FOX AVE. TO W. COLLEGE ST.


DEMO PLAN - W1

FROM STA. 29+00 TO STA. 33+00



Texas Registered RJN GROUP, INC.
Engineering Firm 14755 PRESTON RD. SUITE 710 DALLAS, TEXAS 75254

SCALE | PROJECT NO. SHEET DESIGN: MDH DRAWN: PRR Dec 2021 1"=20' 18-3658-00 | 11 OF 74 CHECKED: JRC

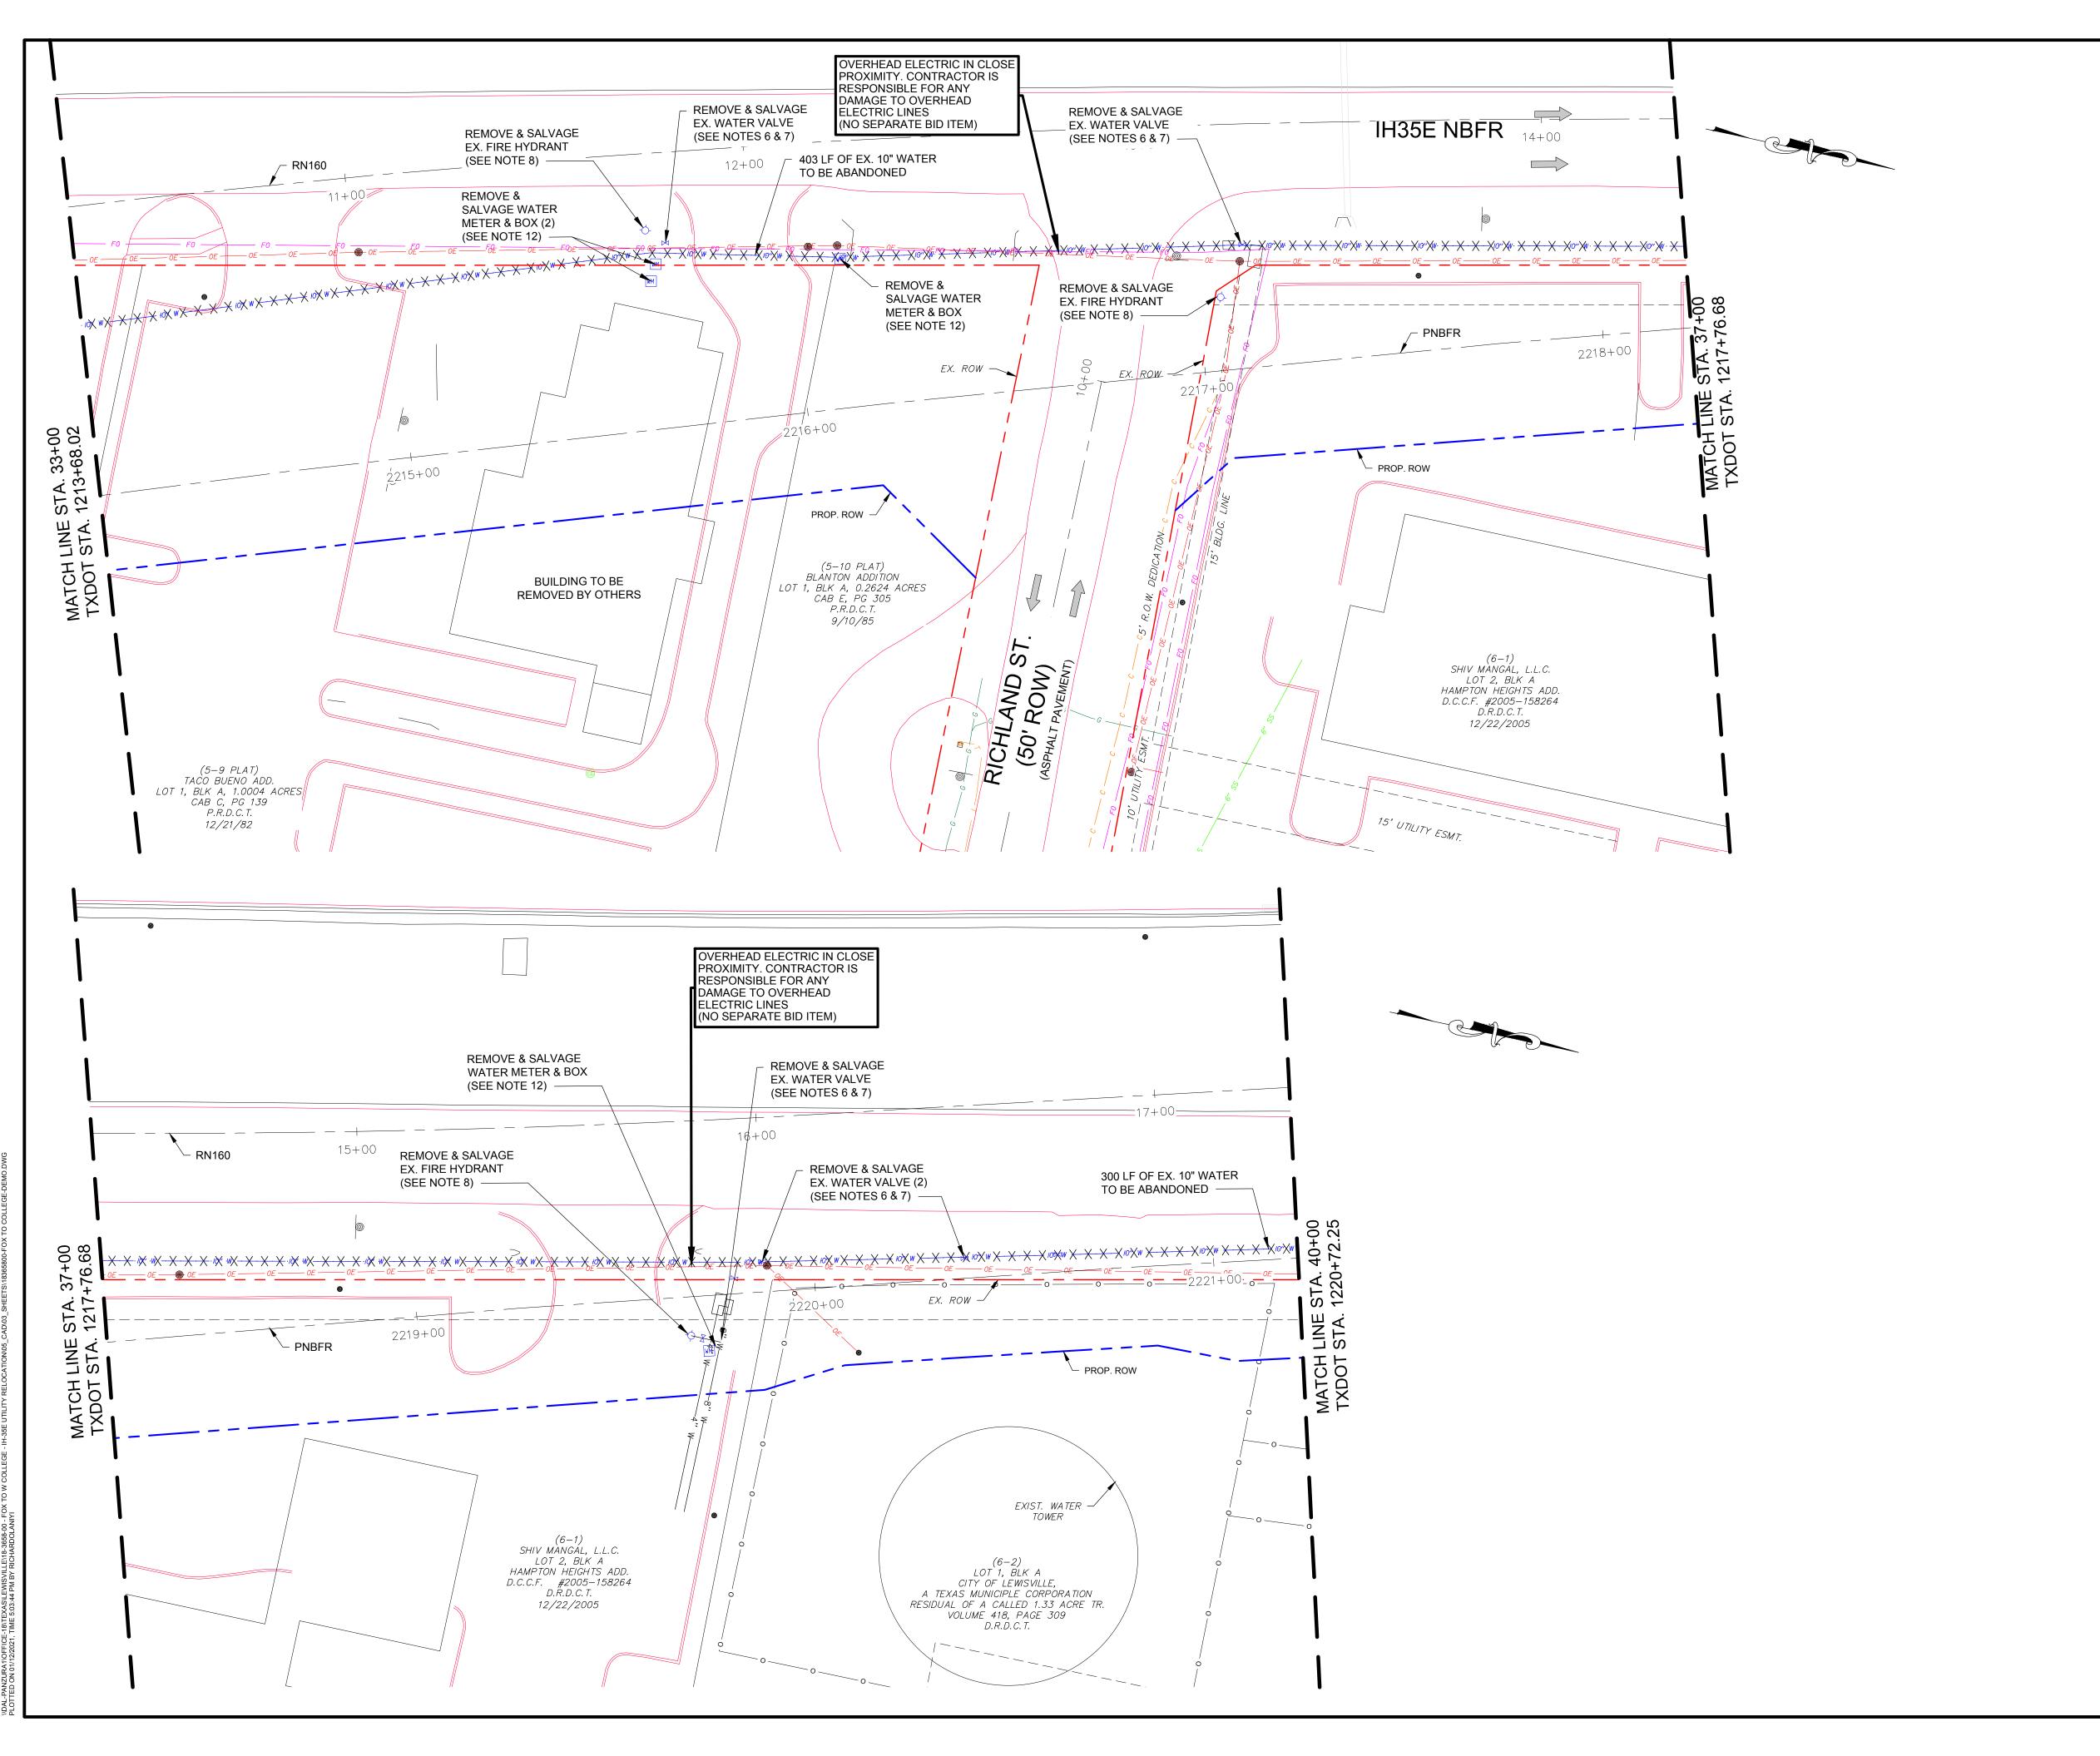

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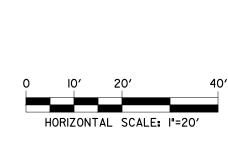
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# **RJN GROUP INC.**

Engineering infrastructure for tomorrow Texas Registered Engineering Firm F−3260 14755 Preston Rd. Suite 710 Dallas TX 75254





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## CITY OF LEWISVILLE, TEXAS ENGINEERING DEPARTMENT

FOX AVE. TO W. COLLEGE ST.

DEMO PLAN - W1


FROM STA. 33+00 TO STA. 40+00



Texas Registered RJN GROUP, INC. results registered RJN GROUP, INC.

Engineering Firm 14755 PRESTON RD. SUITE 710 DALLAS, TEXAS 75254

| DESIGN: MDH                | DATE        | SCALE  | PROJECT NO. | SHEET    |
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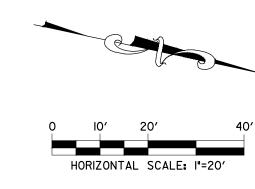
· X·X·X·X·X· WATER ABANDONMENT
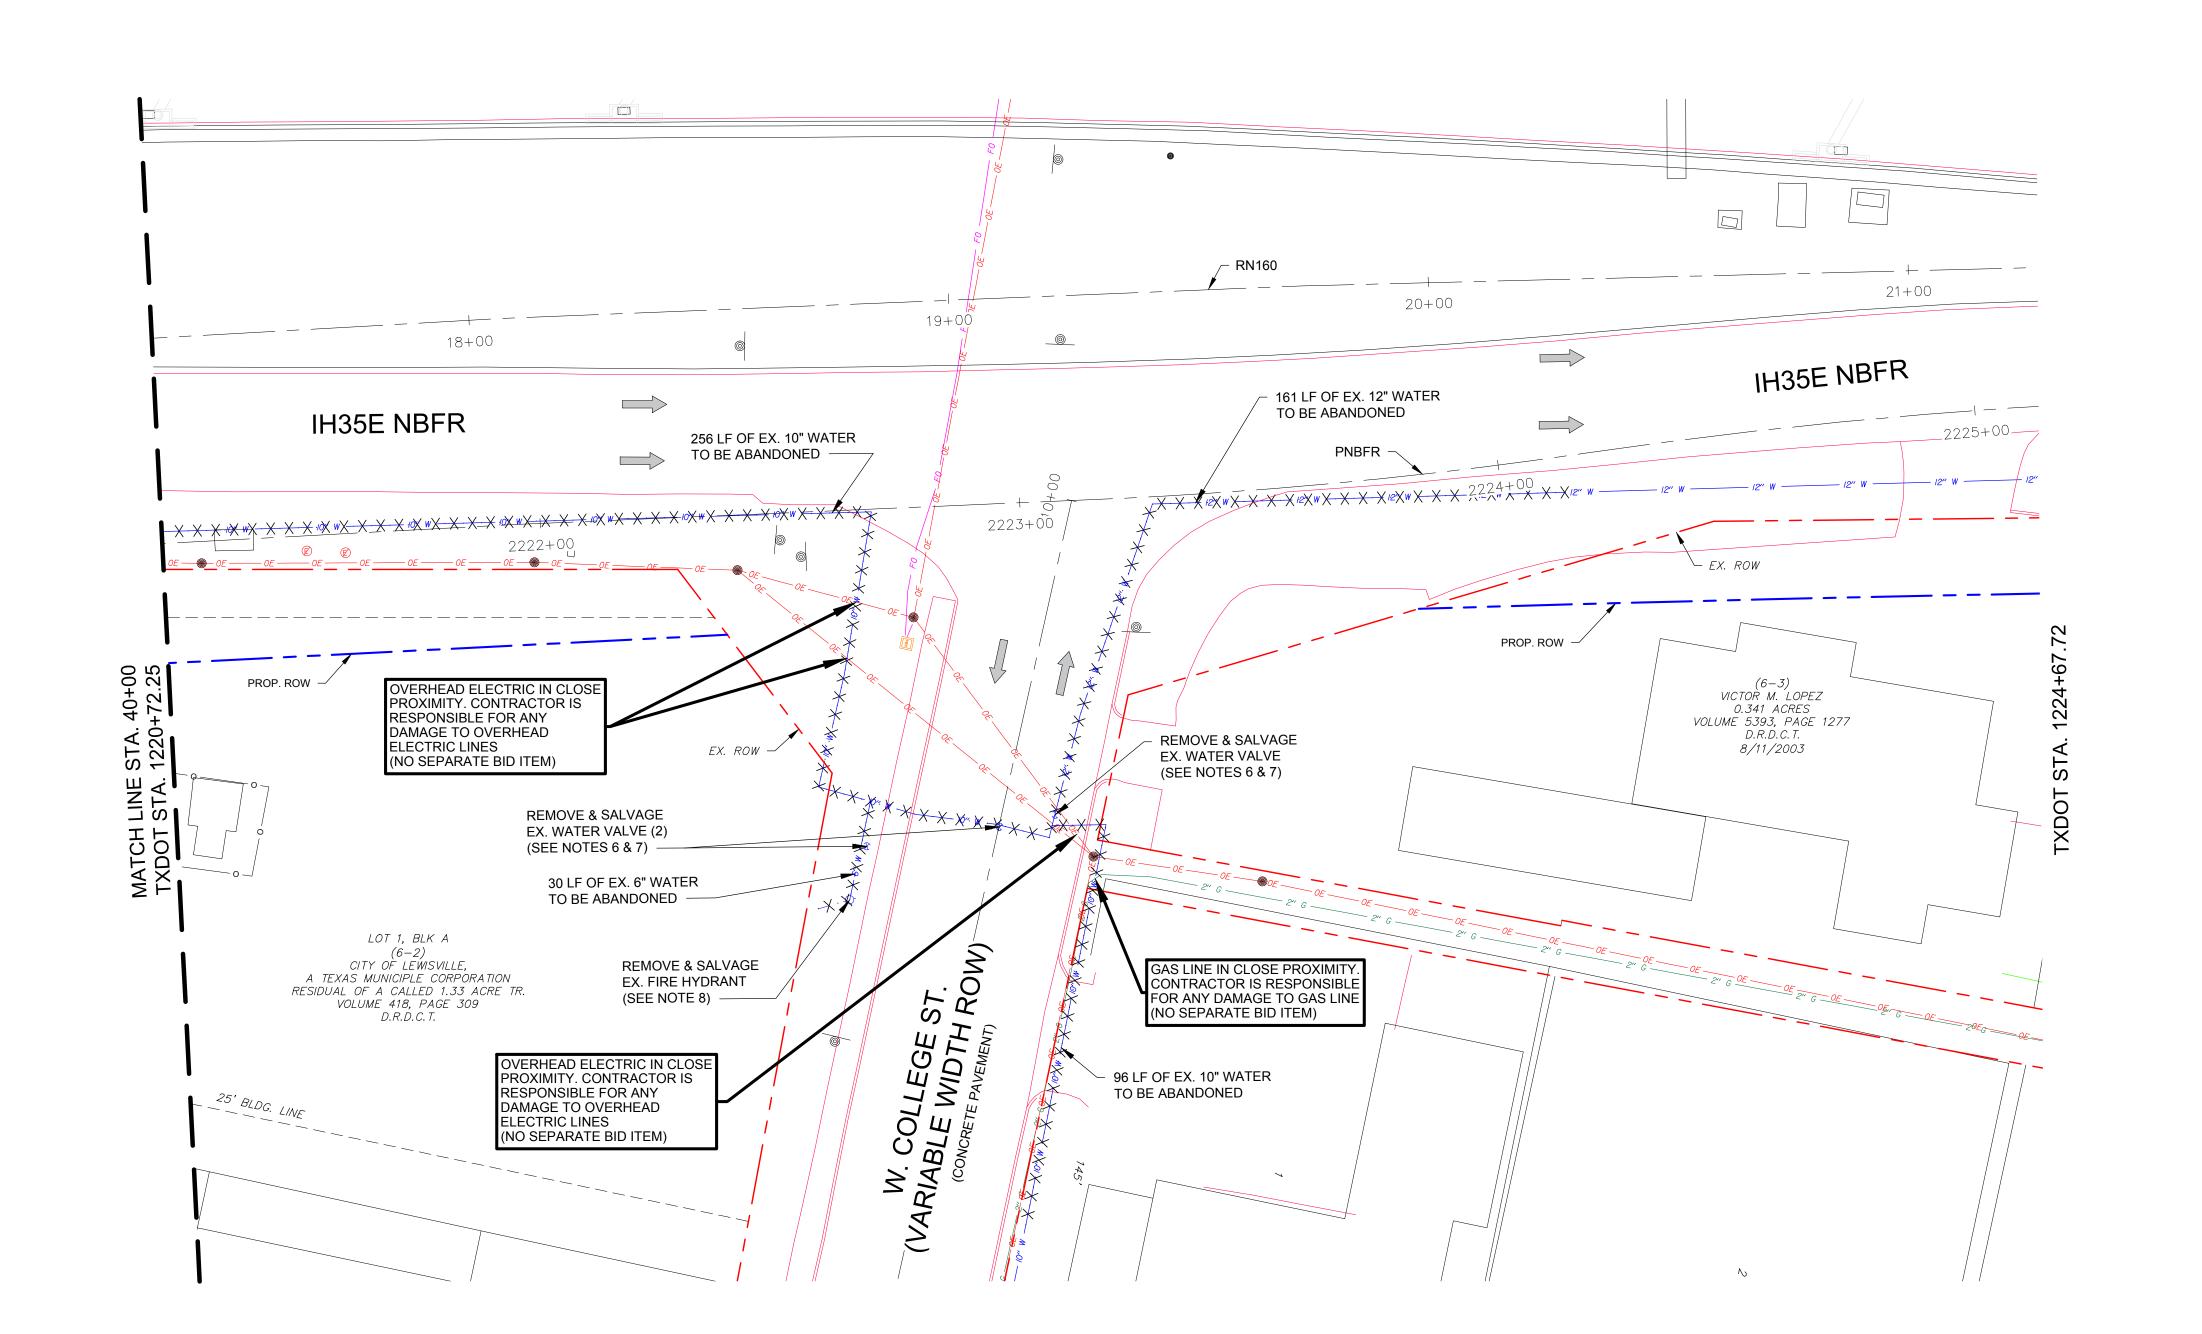
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# **RJN GROUP INC.**

Engineering infrastructure for tomorrow Texas Registered Engineering Firm F-3260 14755 Preston Rd. Suite 710 Dallas TX 75254





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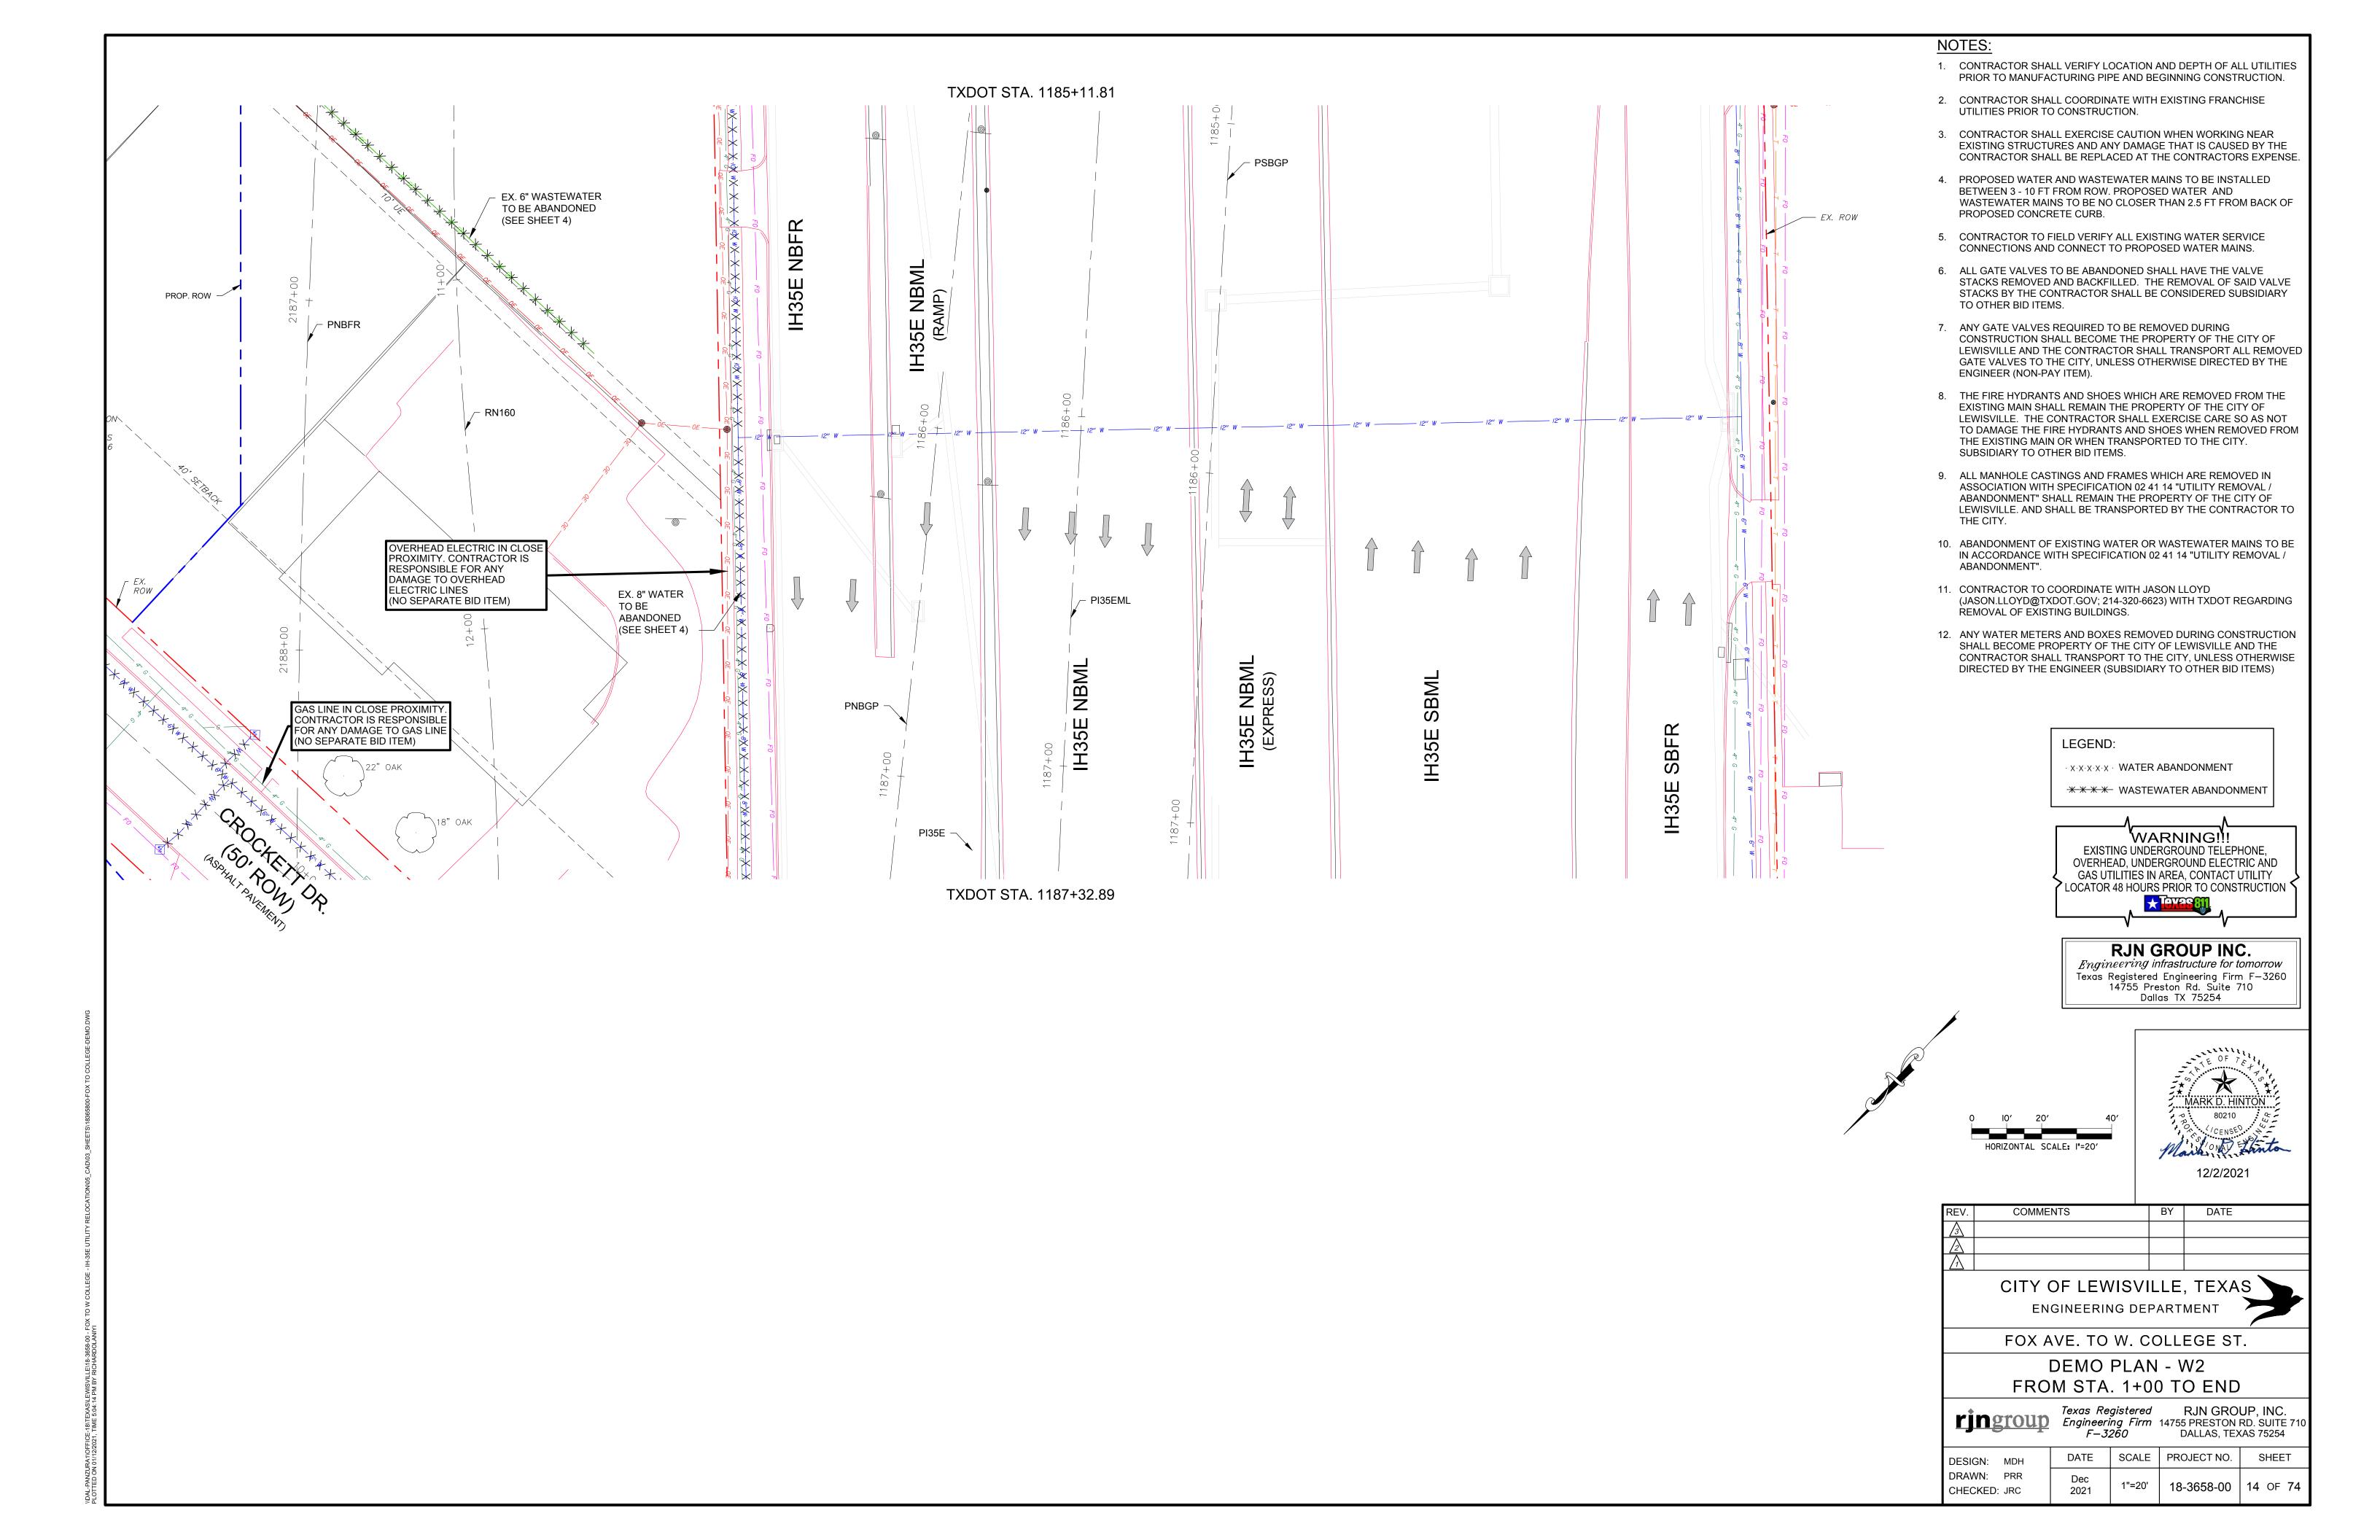
CITY OF LEWISVILLE, TEXAS ENGINEERING DEPARTMENT


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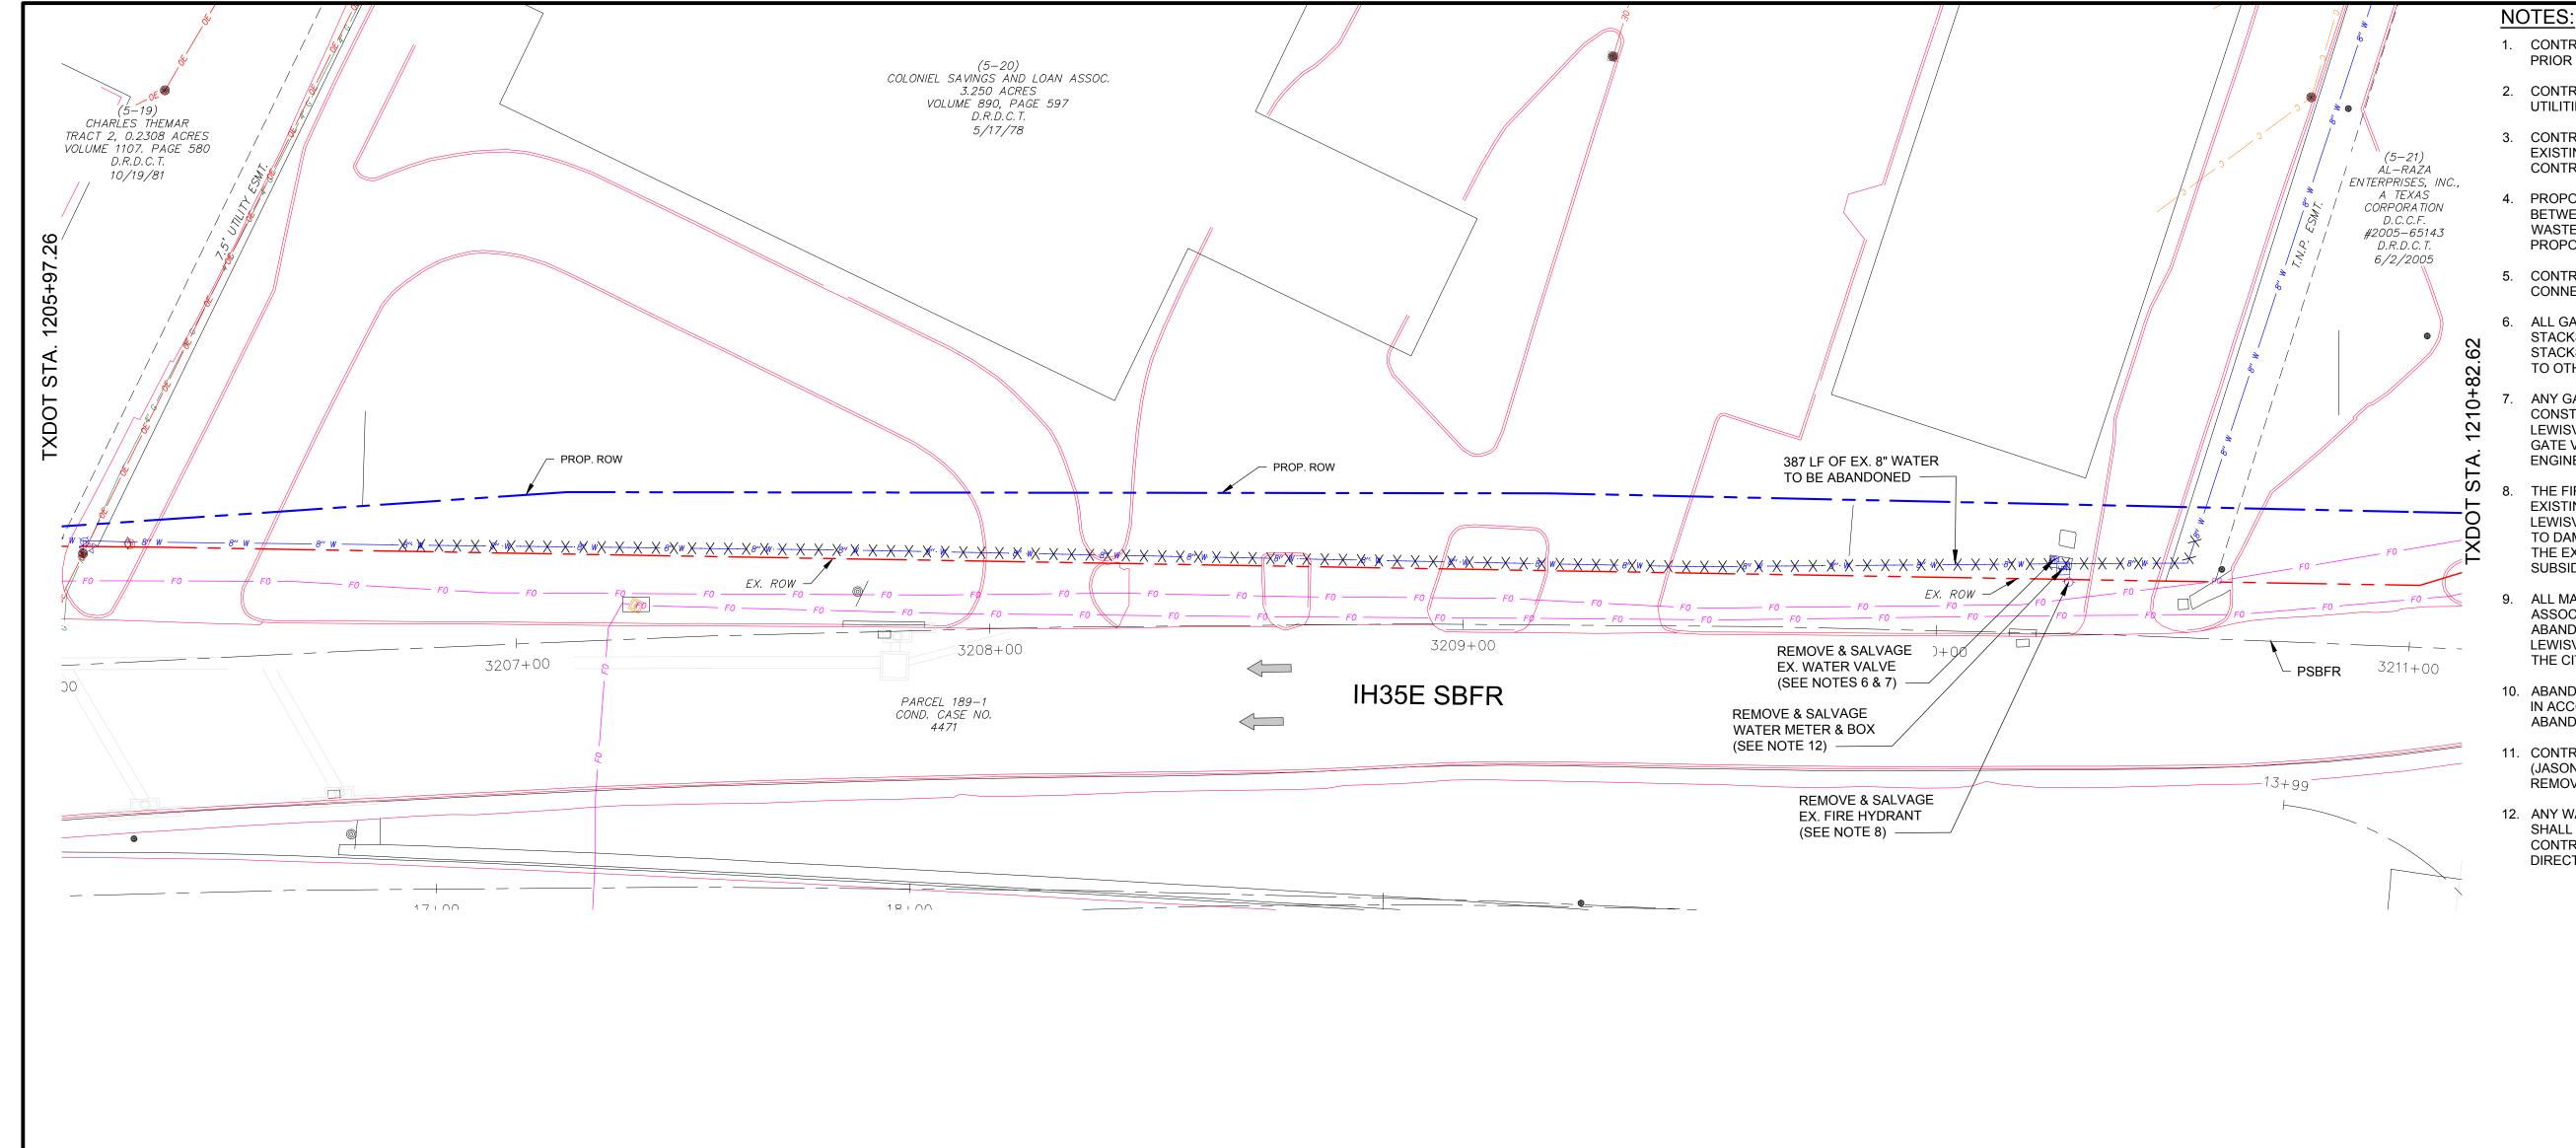
DEMO PLAN - W1 FROM STA. 40+00 TO END

Texas Registered RJN GROUP, INC. Engineering Firm 14755 PRESTON RD. SUITE 710 DALLAS, TEXAS 75254

SCALE | PROJECT NO. SHEET DESIGN: MDH DRAWN: PRR Dec 2021 1"=20' 18-3658-00 | 13 OF 74 CHECKED: JRC





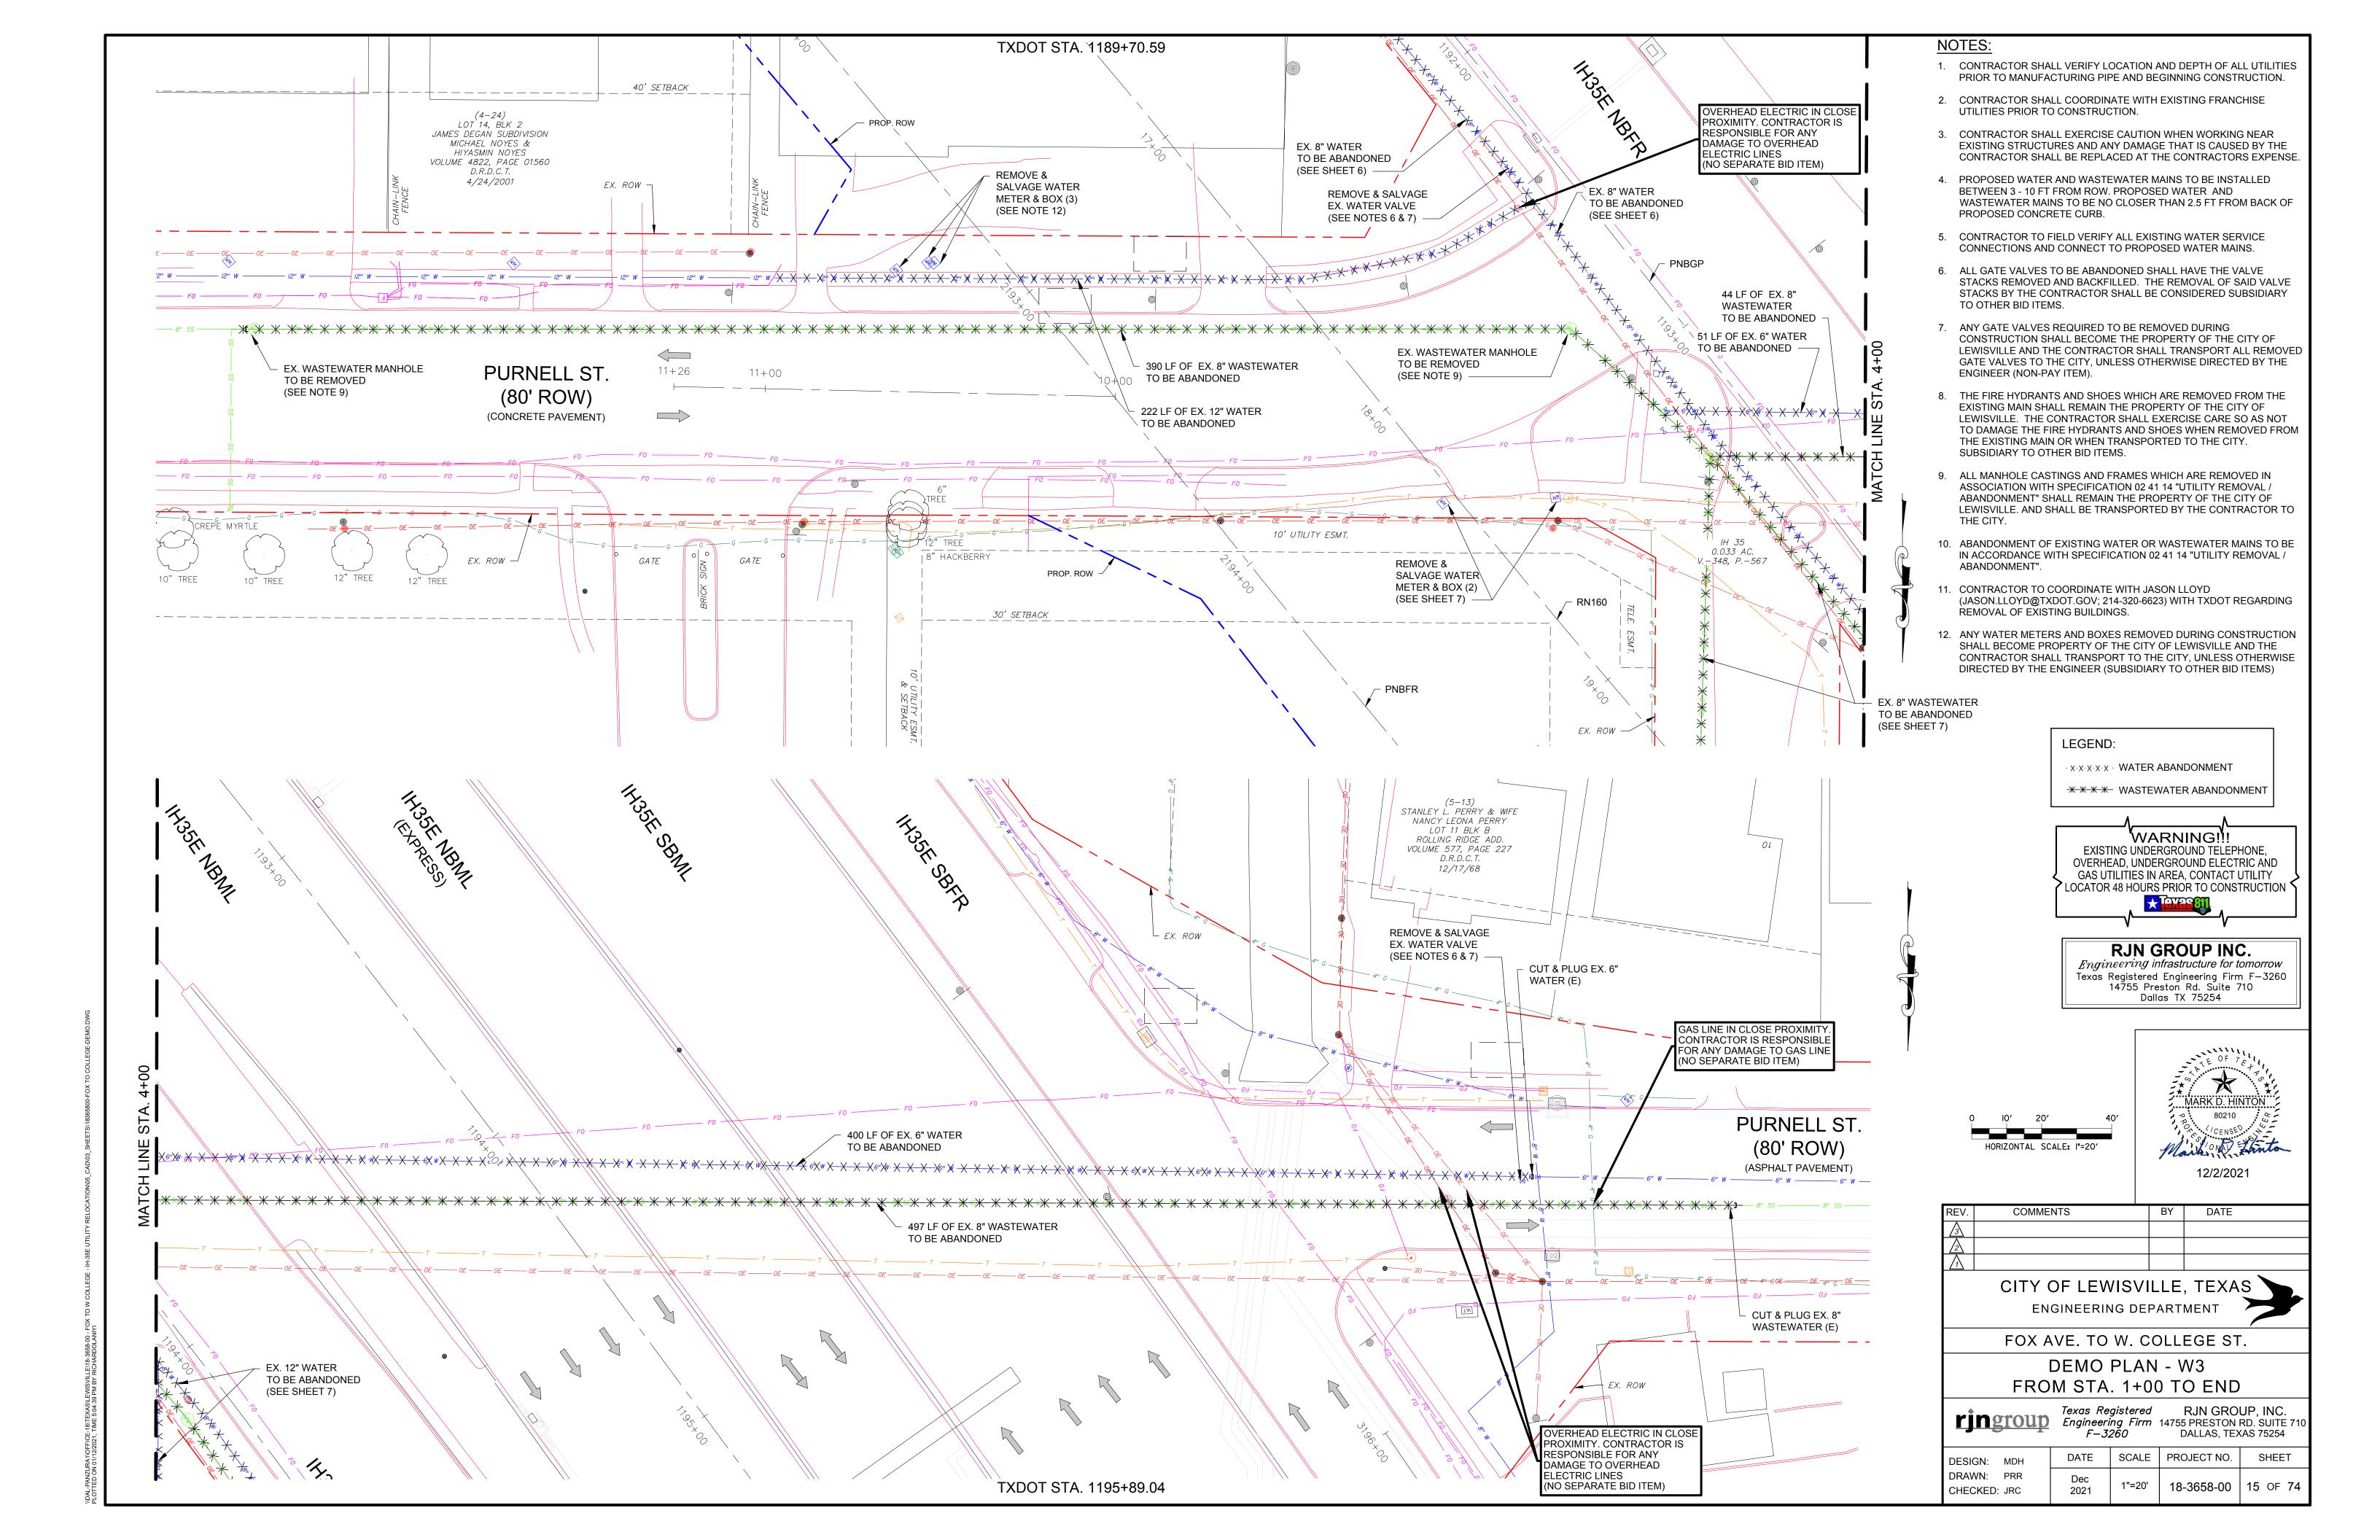

- 1. CONTRACTOR SHALL VERIFY LOCATION AND DEPTH OF ALL UTILITIES PRIOR TO MANUFACTURING PIPE AND BEGINNING CONSTRUCTION.
- 2. CONTRACTOR SHALL COORDINATE WITH EXISTING FRANCHISE UTILITIES PRIOR TO CONSTRUCTION.
- 3. CONTRACTOR SHALL EXERCISE CAUTION WHEN WORKING NEAR EXISTING STRUCTURES AND ANY DAMAGE THAT IS CAUSED BY THE CONTRACTOR SHALL BE REPLACED AT THE CONTRACTORS EXPENSE
- 4. PROPOSED WATER AND WASTEWATER MAINS TO BE INSTALLED BETWEEN 3 - 10 FT FROM ROW. PROPOSED WATER AND WASTEWATER MAINS TO BE NO CLOSER THAN 2.5 FT FROM BACK OF PROPOSED CONCRETE CURB.
- 5. CONTRACTOR TO FIELD VERIFY ALL EXISTING WATER SERVICE CONNECTIONS AND CONNECT TO PROPOSED WATER MAINS.
- 6. ALL GATE VALVES TO BE ABANDONED SHALL HAVE THE VALVE STACKS REMOVED AND BACKFILLED. THE REMOVAL OF SAID VALVE STACKS BY THE CONTRACTOR SHALL BE CONSIDERED SUBSIDIARY TO OTHER BID ITEMS.
- ANY GATE VALVES REQUIRED TO BE REMOVED DURING CONSTRUCTION SHALL BECOME THE PROPERTY OF THE CITY OF LEWISVILLE AND THE CONTRACTOR SHALL TRANSPORT ALL REMOVED GATE VALVES TO THE CITY, UNLESS OTHERWISE DIRECTED BY THE ENGINEER (NON-PAY ITEM).
- THE FIRE HYDRANTS AND SHOES WHICH ARE REMOVED FROM THE EXISTING MAIN SHALL REMAIN THE PROPERTY OF THE CITY OF LEWISVILLE. THE CONTRACTOR SHALL EXERCISE CARE SO AS NOT TO DAMAGE THE FIRE HYDRANTS AND SHOES WHEN REMOVED FROM THE EXISTING MAIN OR WHEN TRANSPORTED TO THE CITY. SUBSIDIARY TO OTHER BID ITEMS.
- ALL MANHOLE CASTINGS AND FRAMES WHICH ARE REMOVED IN ASSOCIATION WITH SPECIFICATION 02 41 14 "UTILITY REMOVAL / ABANDONMENT" SHALL REMAIN THE PROPERTY OF THE CITY OF LEWISVILLE. AND SHALL BE TRANSPORTED BY THE CONTRACTOR TO THE CITY.
- 10. ABANDONMENT OF EXISTING WATER OR WASTEWATER MAINS TO BE IN ACCORDANCE WITH SPECIFICATION 02 41 14 "UTILITY REMOVAL / ABANDONMENT".
- 11. CONTRACTOR TO COORDINATE WITH JASON LLOYD (JASON.LLOYD@TXDOT.GOV; 214-320-6623) WITH TXDOT REGARDING REMOVAL OF EXISTING BUILDINGS.
- 12. ANY WATER METERS AND BOXES REMOVED DURING CONSTRUCTION SHALL BECOME PROPERTY OF THE CITY OF LEWISVILLE AND THE CONTRACTOR SHALL TRANSPORT TO THE CITY, UNLESS OTHERWISE DIRECTED BY THE ENGINEER (SUBSIDIARY TO OTHER BID ITEMS)

#### LEGEND:


· X·X·X·X·X· WATER ABANDONMENT

\*\* \* \* \* WASTEWATER ABANDONMENT


WARNING!!! EXISTING UNDERGROUND TELEPHONE, OVERHEAD, UNDERGROUND ELECTRIC AND GAS UTILITIES IN AREA, CONTACT UTILITY  $^{ar{\prime}}$  LOCATOR 48 HOURS PRIOR TO CONSTRUCTION  $^{\circ}$ 

# **RJN GROUP INC.**

Engineering infrastructure for tomorrow Texas Registered Engineering Firm F-3260 14755 Preston Rd. Suite 710 Dallas TX 75254

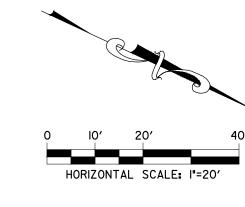

COMMENTS

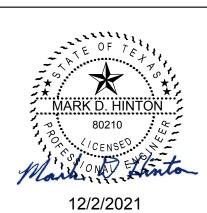

| BY | DATE |
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| 7 |                 |     |         |
|   | CITY OF LEWISVI | LLE | , TEXAS |

ENGINEERING DEPARTMENT

FOX AVE. TO W. COLLEGE ST.

DEMO PLAN - W4 FROM STA. 1+00 TO END



Texas Registered RJN GROUP, INC.
Engineering Firm 14755 PRESTON RD. SUITE 710
F-3260 DALLAS, TEXAS 75254

| DESIGN: MDH  | DATE | SCALE   | PROJECT NO. | SHEET    |
|--------------|------|---------|-------------|----------|
| DRAWN: PRR   | Dec  | 411 001 | 40.00-0.00  | 40 74    |
| CHECKED: JRC | 2021 | 1"=20'  | 18-3658-00  | 16 OF /4 |

